




Fabric Reinforcement Schedule (basement)					
Mark	Type	Cut Overall Length	Cut Overall Width	Count	Total weight
1	SL82	6000	2400	6	312.00 kg
2	SL82	5560	2400	3	144.56 kg
3	SL82	4975	2400	1	43.12 kg
4	SL82	4820	2400	1	41.77 kg
5	SL82	4245	2400	1	36.79 kg
6	SL82	4080	2400	3	105.56 kg
7	SL82	4470	1457	1	23.52 kg
8	SL82	2990	1940	1	20.95 kg
9	SL82	3090	1040	1	11.60 kg
Grand total					739.87 kg

Rebar Schedule (basement)									
Schedule Mark	Bar Type	Shape	SIZE, (mm)			Total Bar Length, (mm)	Quantity	WEIGHT, (kg)	
			B	C	D				E
1	N12	00	600	0	0	600	15	8.28	
2	N12	00	2513	0	0	2513	5	11.56	
3	N12	00	967	0	0	967	7	6.23	
4	N12	00	992	0	0	992	17	15.51	
5	N12	00	1110	0	0	1110	11	11.24	
6	N12	00	1128	0	0	1128	8	8.30	
7	N12	00	1313	0	0	1313	8	9.67	
8	N12	00	1325	0	0	1325	7	8.53	
9	N12	00	1649	0	0	1649	8	12.14	
10	N12	00	2128	0	0	2128	3	5.87	
11	N12	00	2480	0	0	2480	4	9.13	
12	N12	00	2580	0	0	2580	3	7.12	
13	N12	00	2638	0	0	2638	3	7.28	
14	N12	00	2745	0	0	2745	8	20.21	
15	N12	00	3230	0	0	3230	25	74.29	
16	N12	00	3420	0	0	3420	8	25.17	
17	N12	00	3780	0	0	3780	11	38.26	
18	N12	00	3955	0	0	3955	8	29.11	
19	N12	00	4186	0	0	4186	3	11.55	
20	N12	00	4500	0	0	4500	4	16.56	
21	N12	17A	300	600	0	869	44	35.19	
22	N12	00	4950	0	0	4950	13	59.20	
23	N12	00	5010	0	0	5010	4	18.44	
24	N12	00	6000	0	0	6000	70	386.40	
25	N16	00	635	0	0	635	9	9.31	
26	N16	00	2720	0	0	2720	80	354.69	
26	N16	00	2950	0	0	2950	23	110.60	
27	N20	00	483	0	0	483	12	14.78	
28	N20	00	753	0	0	753	6	11.52	
29	N20	00	777	0	0	777	18	35.64	
30	N20	00	2720	0	0	2720	6	41.62	
30	N20	00	2950	0	0	2950	128	962.88	
31	N12	17A	600	600	0	1169	55	59.17	
32	N12	00	4610	0	0	4610	11	46.66	
33	N16	17A	300	700	0	959	488	758.23	
Grand total							1133	3240.32	

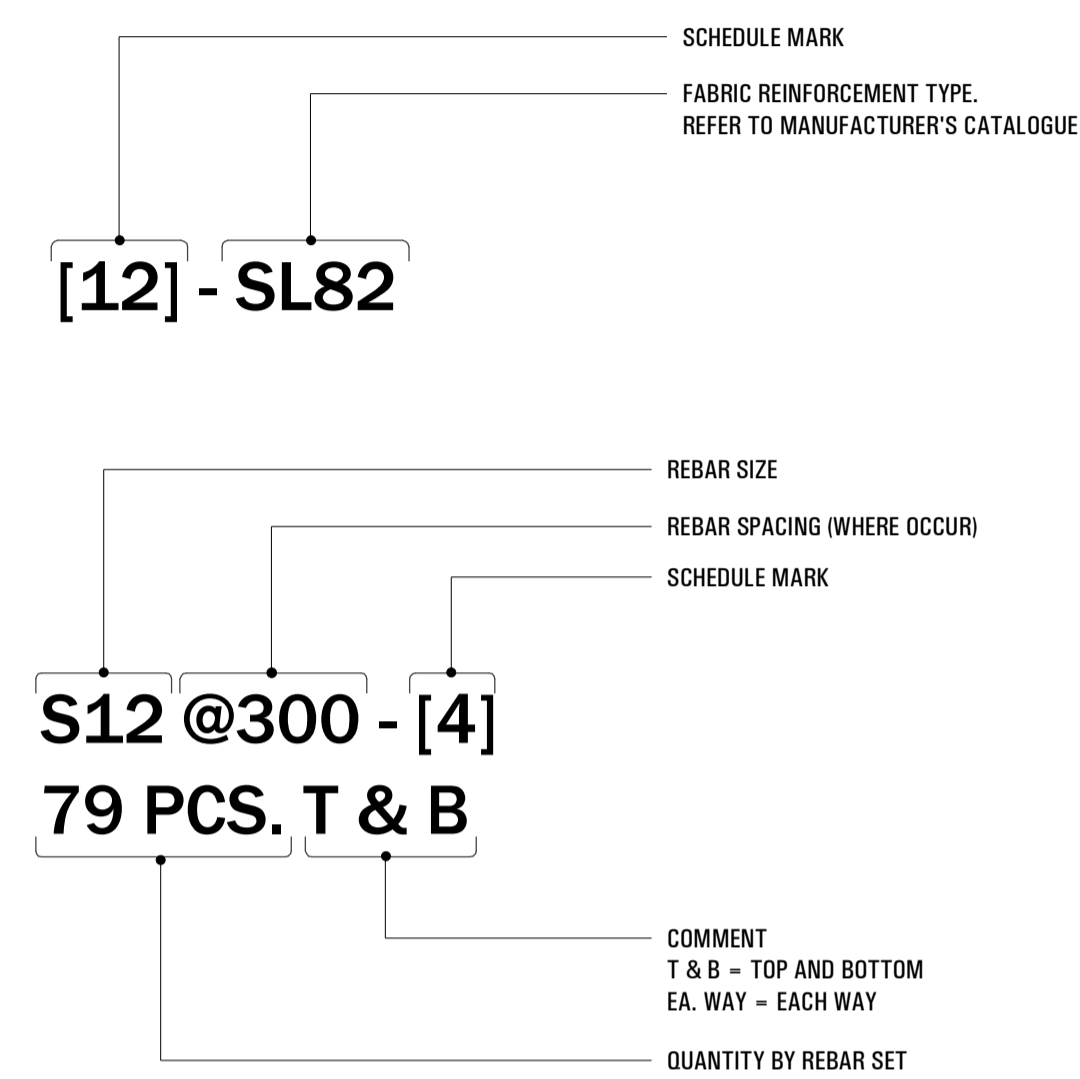

1 BASEMENT PLAN
SCALE: 1:50

REBAR SHAPES

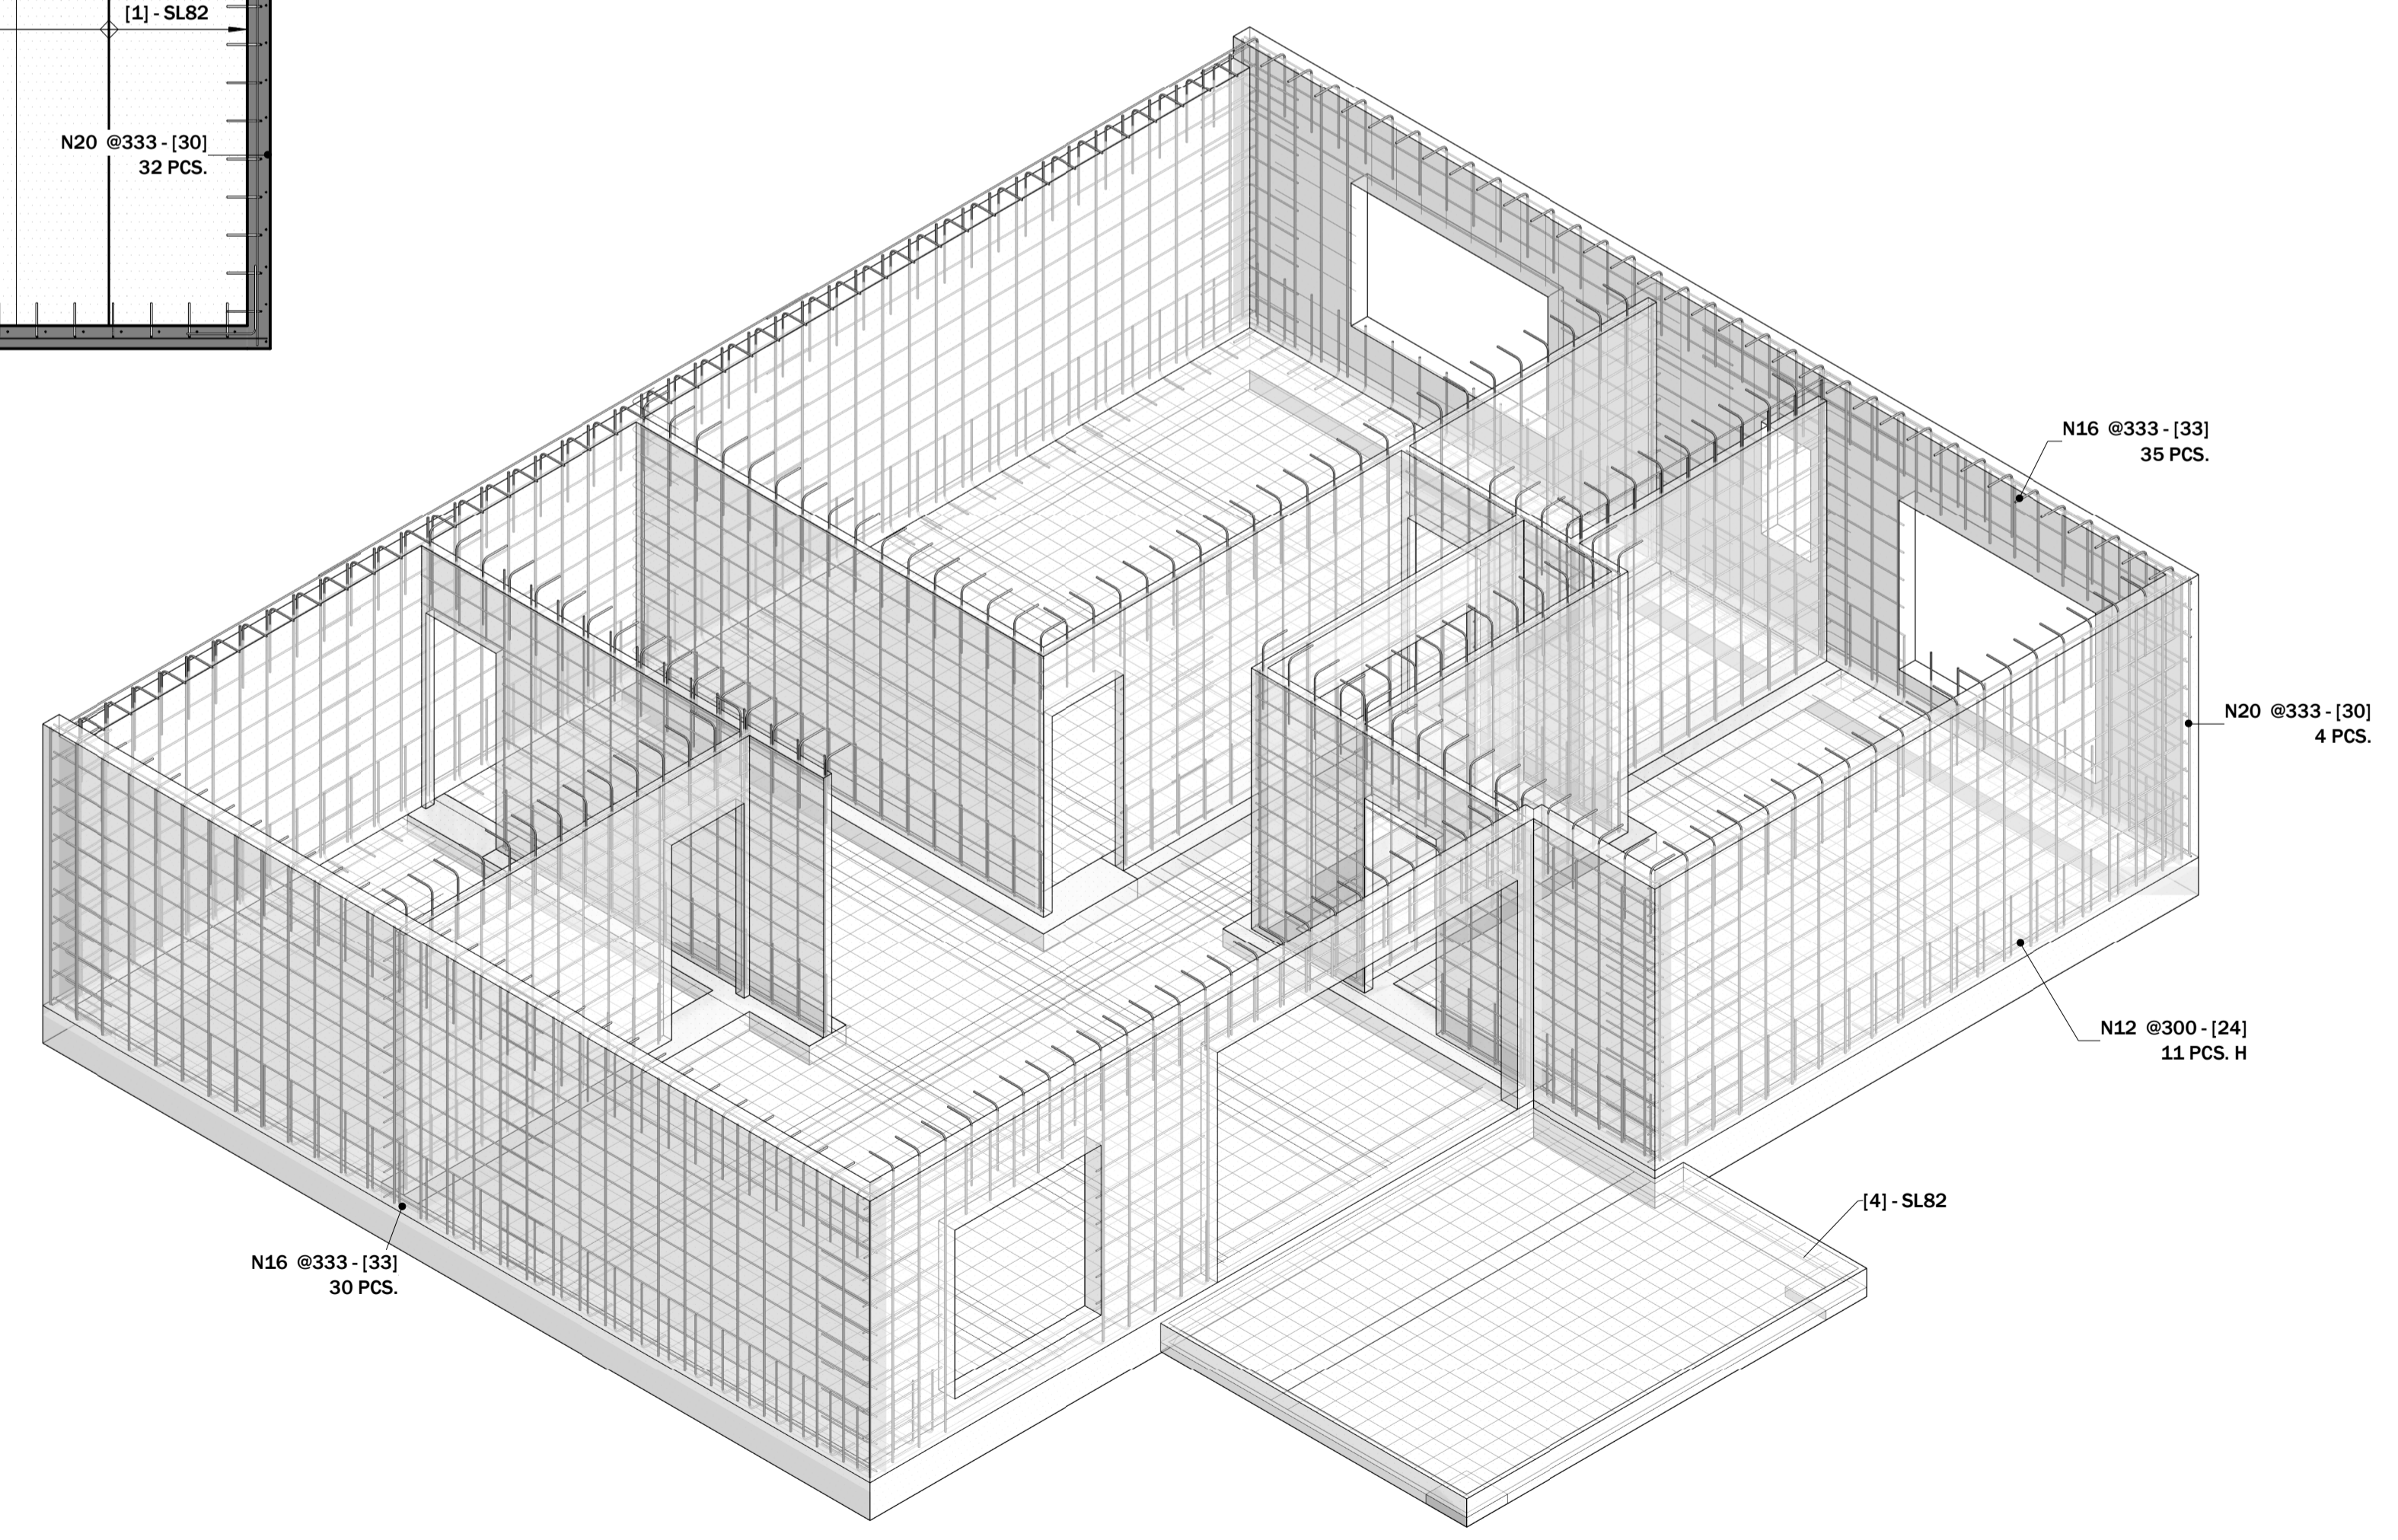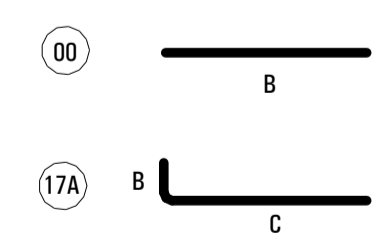

2 BASEMENT 3D VIEW
SCALE:

SEAL:

CONTACT:

PROJECT:


**REBAR SHOP DRAWINGS FOR
RESIDENCE AT
10 DUNCAN PLACE, NORTH ROCKS, NSW 2151**

REVISIONS		
MARK	DATE	DESCRIPTION


PROJECT NO:
SCALE: As indicated
DATE: 09/28/20
DRAWN BY:
CHECKED BY:

SHEET TITLE:
BASEMENT


SHEET NO:
SD101

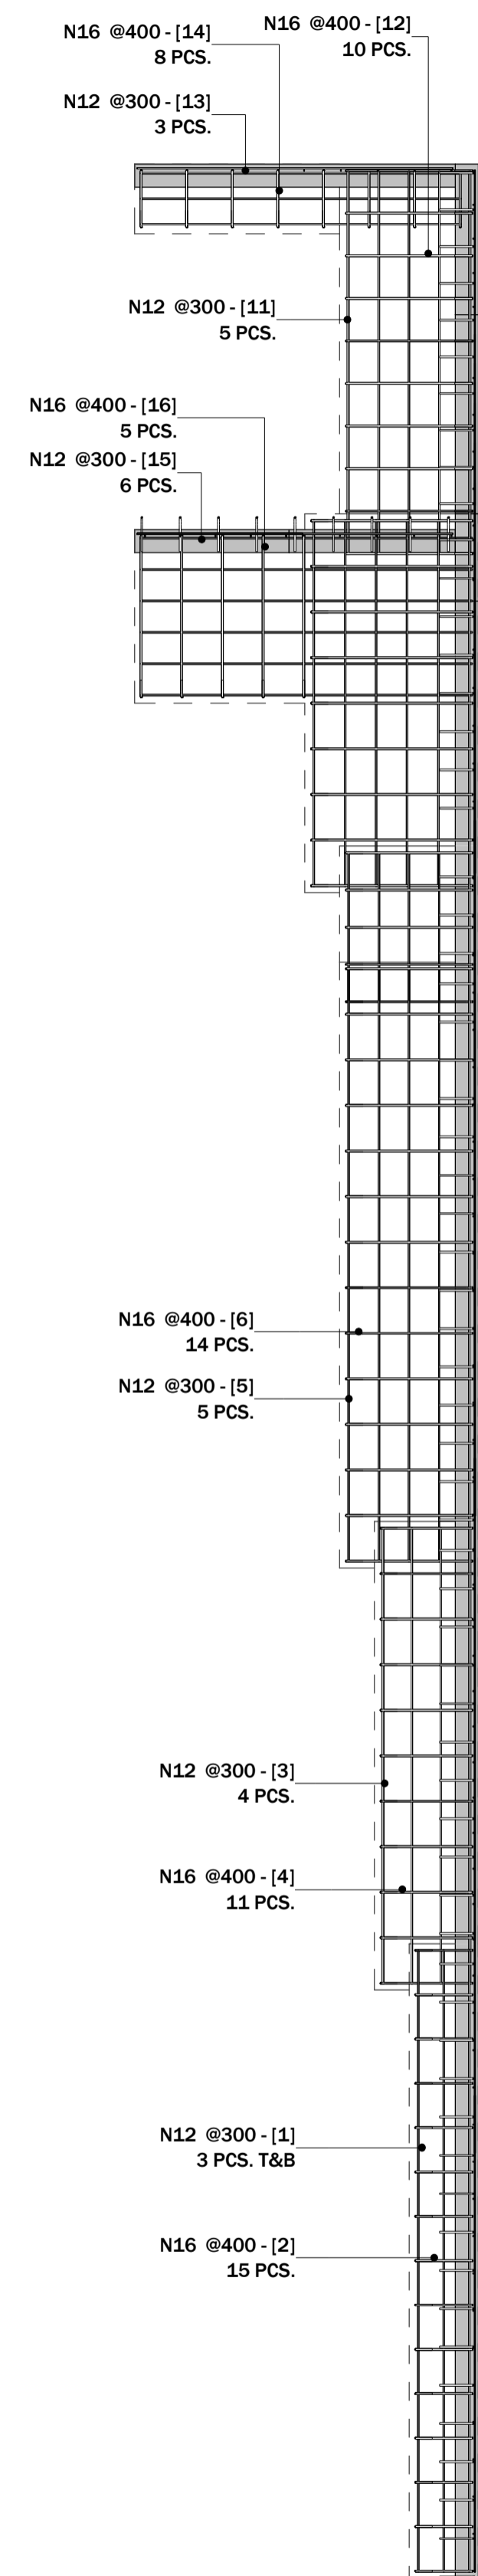



1 NORTH RETAINING WALL PLAN
SCALE: 1:50

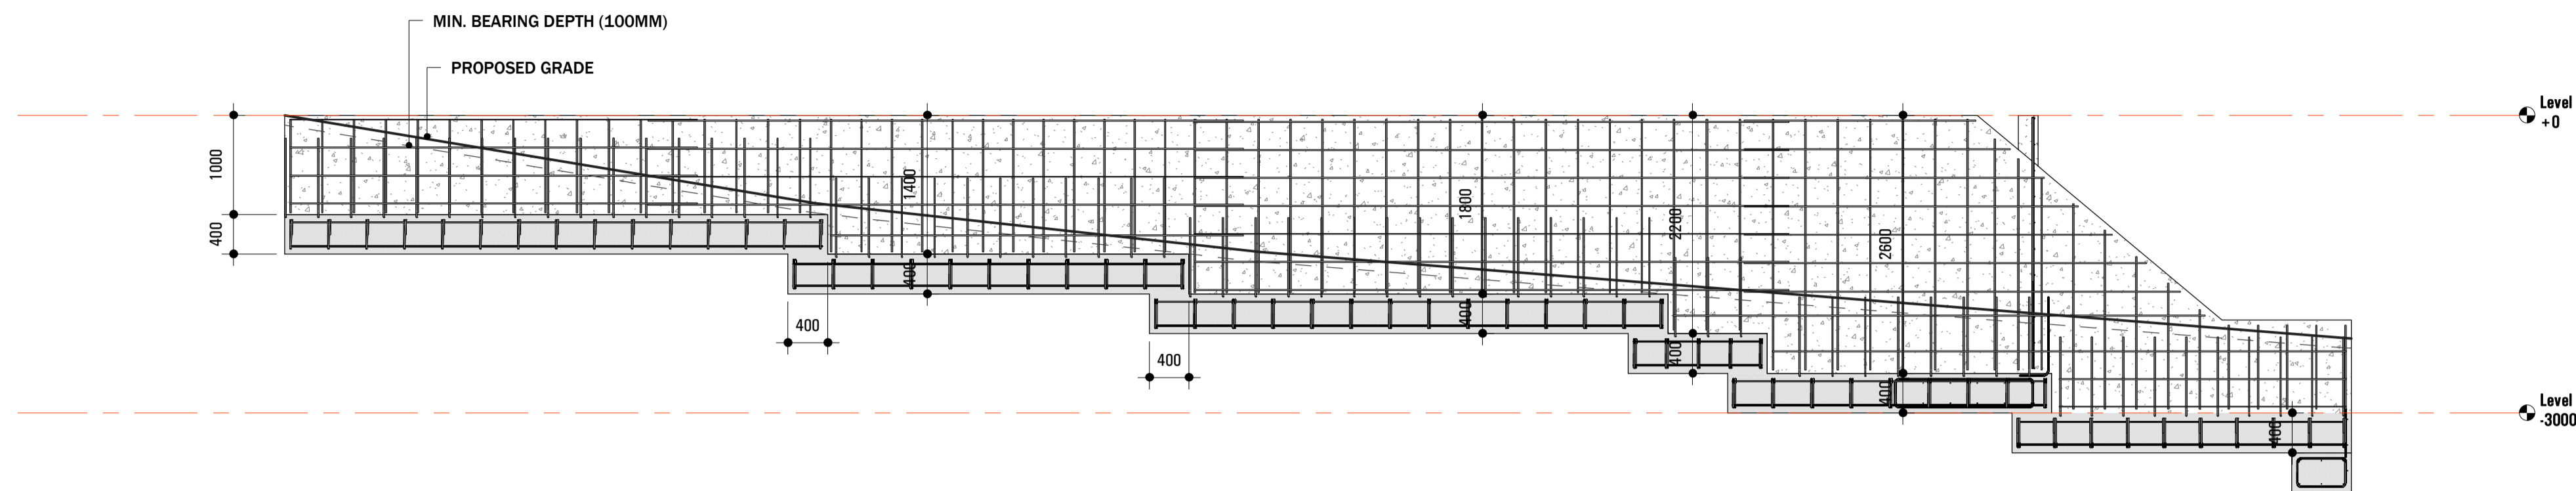

2 NORTH RETAINING WALL ELEVATION
SCALE: 1:50

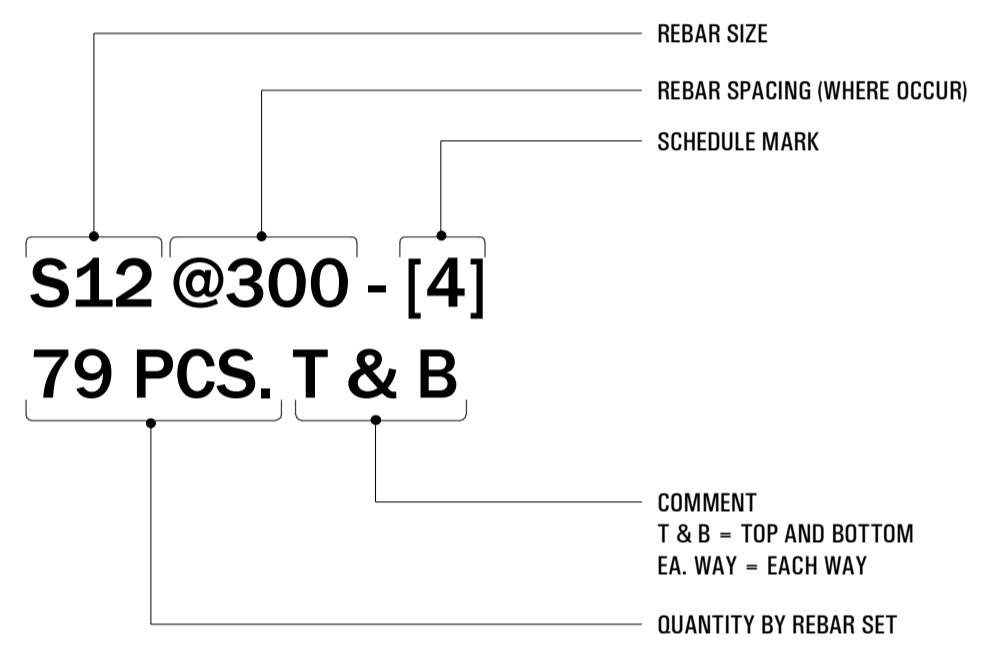

REBAR SHAPES

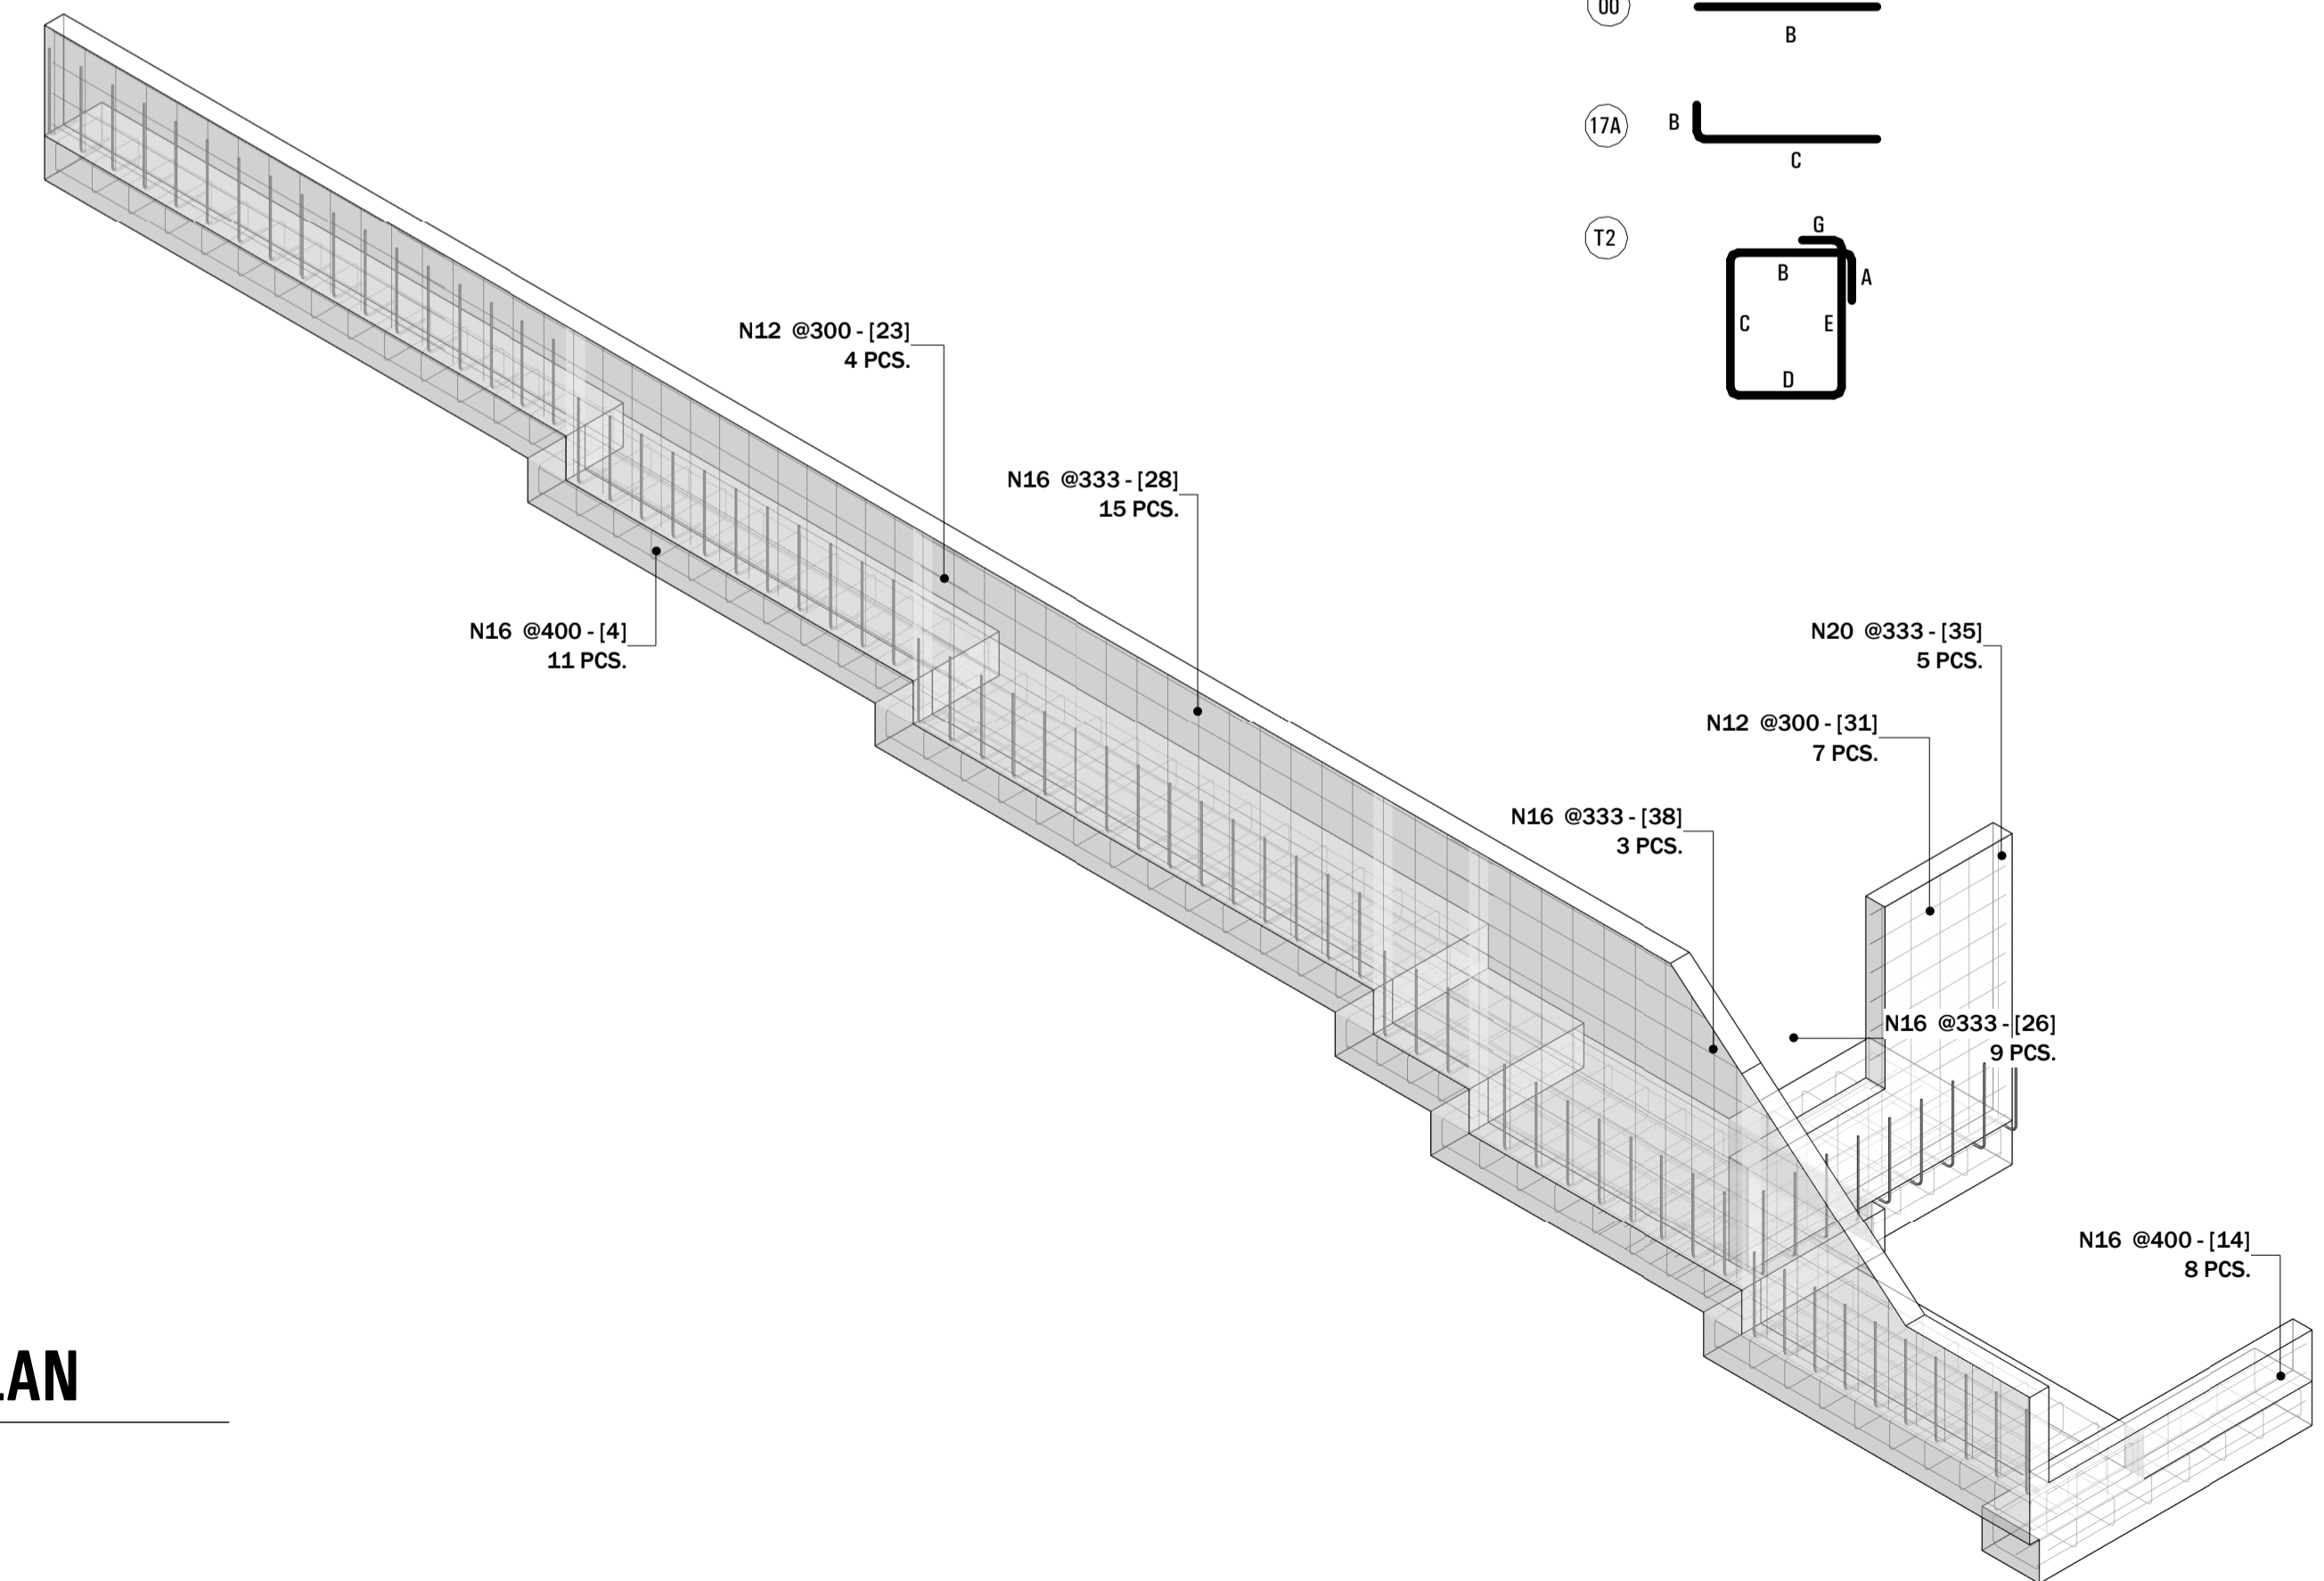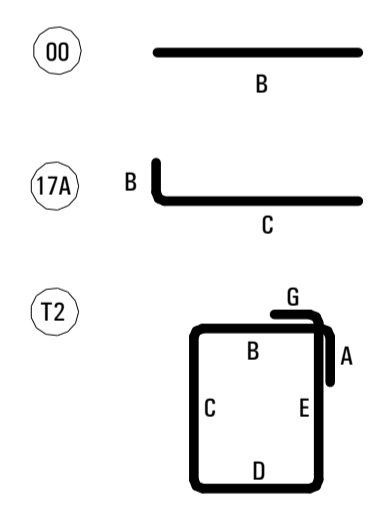

Rebar Schedule (N retaining wall)

Schedule Mark	Bar Type	Shape	SIZE, (mm)						Total Bar Length, (mm)	Quantity	WEIGHT, (kg)
			A	B	C	D	E	G			
1	N12	00	0	5372	0	0	0	0	5372	6	29.66
2	N16	T2	152	300	500	300	500	152	1738	15	42.49
3	N12	00	0	3943	0	0	0	0	3943	8	29.02
4	N16	T2	152	800	300	800	300	152	2338	11	41.92
5	N12	00	0	5128	0	0	0	0	5128	10	47.18
6	N16	T2	152	1100	300	1100	300	152	2938	14	67.04
7	N12	00	0	1300	0	0	0	0	1300	10	11.96
8	N16	T2	152	1100	300	1100	300	152	2938	5	23.94
9	N12	00	0	3166	0	0	0	0	3166	12	34.95
10	N16	T2	152	1400	300	1400	300	152	3538	9	51.90
11	N12	00	0	3320	0	0	0	0	3320	10	30.55
12	N16	T2	152	1100	300	1100	300	152	2938	10	47.89
13	N12	00	0	2770	0	0	0	0	2770	6	15.29
14	N16	T2	152	500	300	500	300	152	1738	8	22.66
15	N12	00	0	2870	0	0	0	0	2870	12	31.68
16	N16	T2	152	300	1400	300	1400	152	3538	5	28.83
17	N12	00	0	2896	0	0	0	0	2896	2	5.33
18	N12	00	0	4113	0	0	0	0	4113	4	15.14
19	N12	00	0	4155	0	0	0	0	4155	1	3.82
20	N12	00	0	5366	0	0	0	0	5366	1	4.94
21	N12	00	0	5786	0	0	0	0	5786	1	5.32
23	N12	00	0	6000	0	0	0	0	6000	11	60.72
24	N16	00	0	848	0	0	0	0	848	5	6.91
25	N16	00	0	944	0	0	0	0	944	17	26.17
26	N16	17A	0	300	800	0	0	0	1059	73	126.02
27	N16	00	0	1337	0	0	0	0	1337	12	26.16
28	N16	00	0	1745	0	0	0	0	1745	15	42.66
29	N16	00	0	2528	0	0	0	0	2528	7	45.12
30	N20	00	0	2122	0	0	0	0	2122	3	16.23
31	N12	00	0	1430	0	0	0	0	1430	7	9.21
32	N12	00	0	2722	0	0	0	0	2722	8	20.04
33	N16	00	0	489	0	0	0	0	489	5	3.99
34	N16	00	0	877	0	0	0	0	877	5	7.15
35	N20	00	0	2525	0	0	0	0	2525	5	32.19
36	N12	00	0	2340	0	0	0	0	2340	1	2.15
36	N12	00	0	2684	0	0	0	0	2684	1	2.47
36	N12	00	0	3027	0	0	0	0	3027	1	2.79
36	N12	00	0	3371	0	0	0	0	3371	1	3.10
36	N12	00	0	3714	0	0	0	0	3714	1	3.42
36	N12	00	0	4058	0	0	0	0	4058	1	3.73
36	N12	00	0	4401	0	0	0	0	4401	1	4.05
37	N16	00	0	1003	0	0	0	0	1003	1	1.64
37	N16	00	0	1270	0	0	0	0	1270	1	2.07
37	N16	00	0	1536	0	0	0	0	1536	1	2.50
37	N16	00	0	1802	0	0	0	0	1802	1	2.94
37	N16	00	0	2069	0	0	0	0	2069	1	3.37
38	N16	00	0	1936	0	0	0	0	1936	1	3.16
38	N16	00	0	2133	0	0	0	0	2133	1	3.48
38	N16	00	0	2329	0	0	0	0	2329	1	3.80
Grand total									348	1058.74	

SEAL:

CONTACT:

PROJECT:

**REBAR SHOP DRAWINGS FOR
 RESIDENCE AT
 10 DUNCAN PLACE, NORTH ROCKS, NSW 2151**



REVISIONS

MARK	DATE	DESCRIPTION



PROJECT NO:
 SCALE: As indicated
 DATE: 09/28/20
 DRAWN BY:
 CHECKED BY:

SHEET TITLE:
NORTH RETAINING WALL


SHEET NO:
SD103

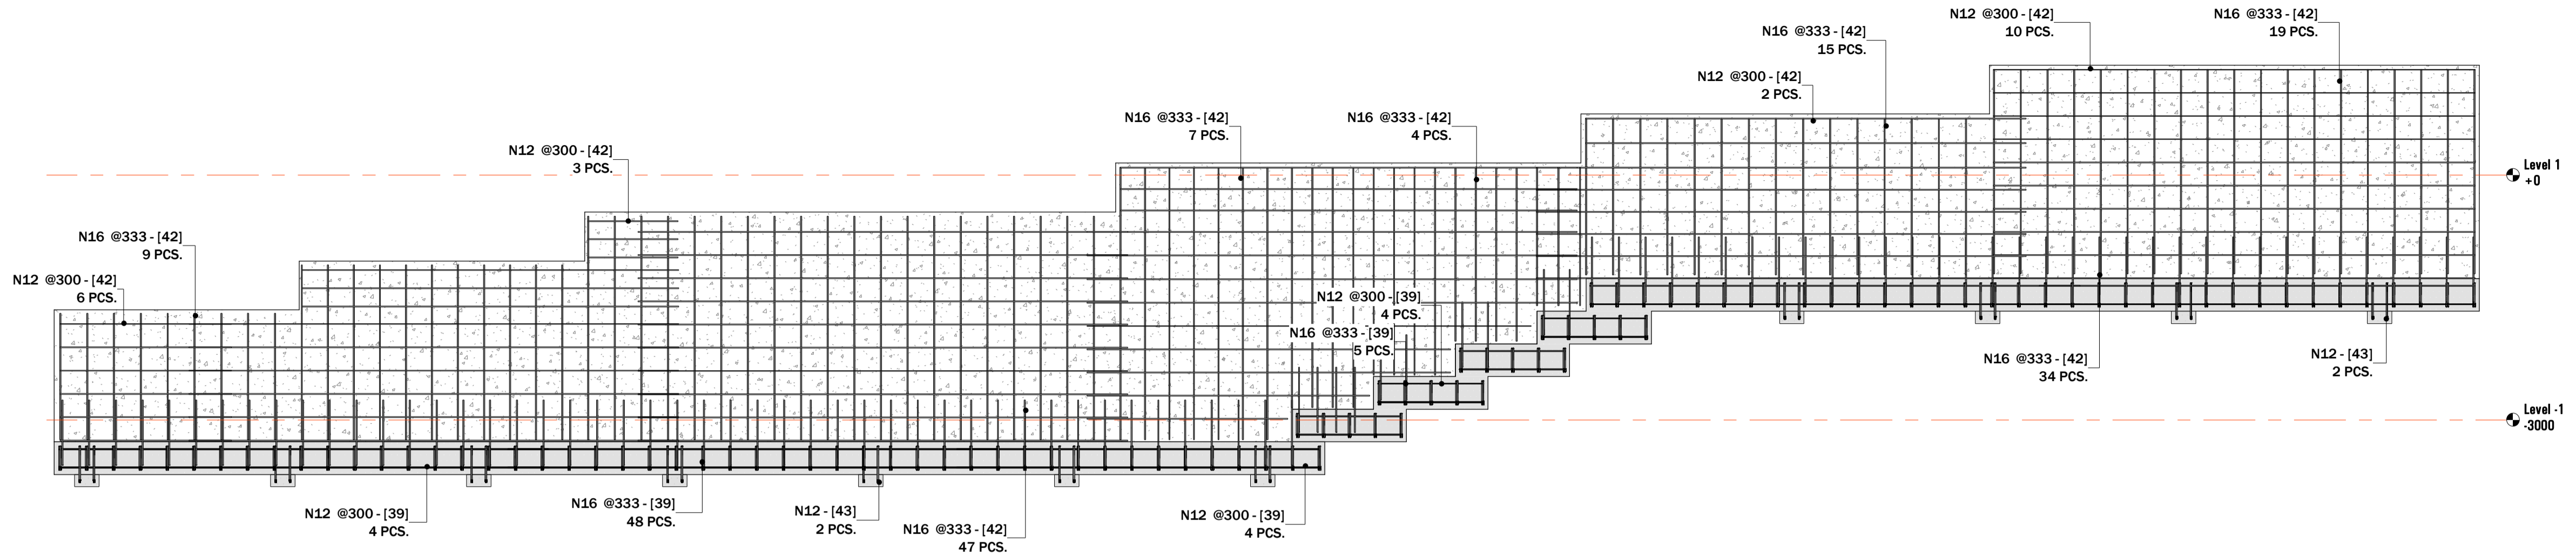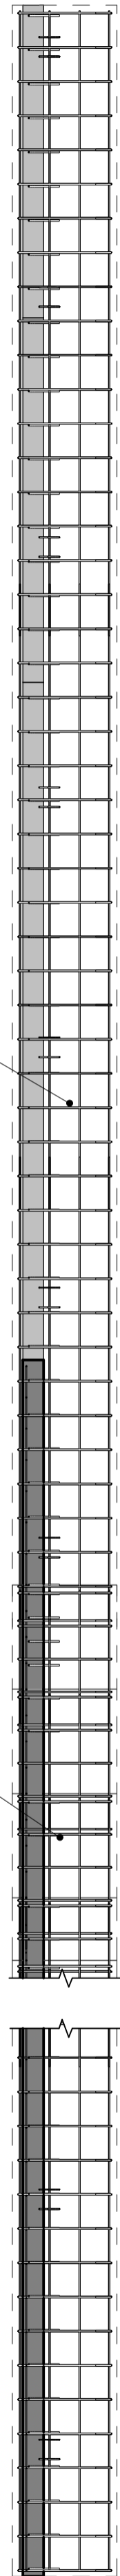

2 SOUTH RETAINING WALL ELEVATION
SCALE: 1:50

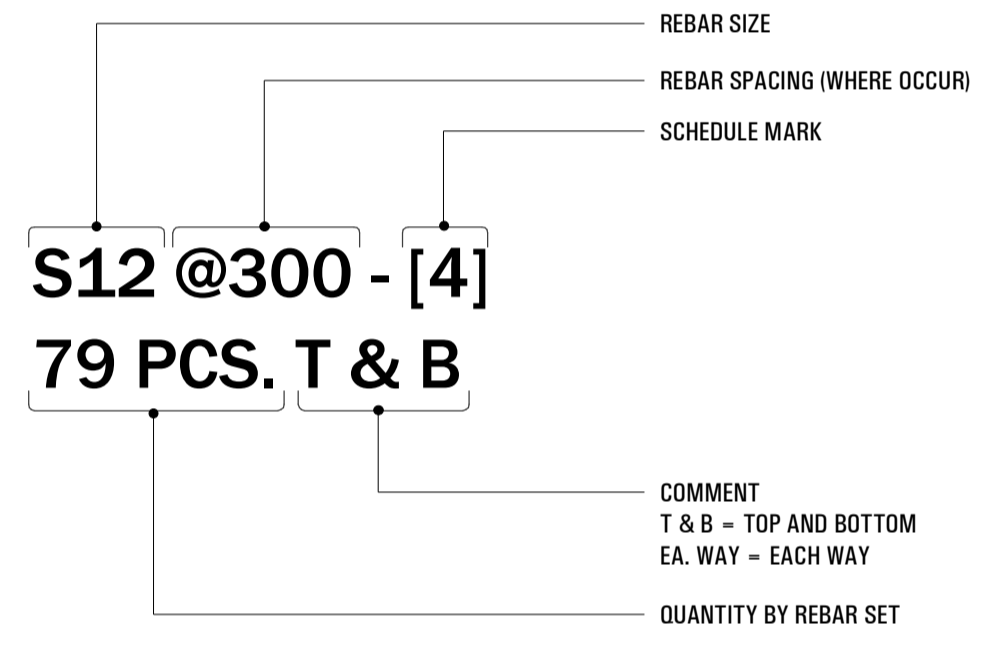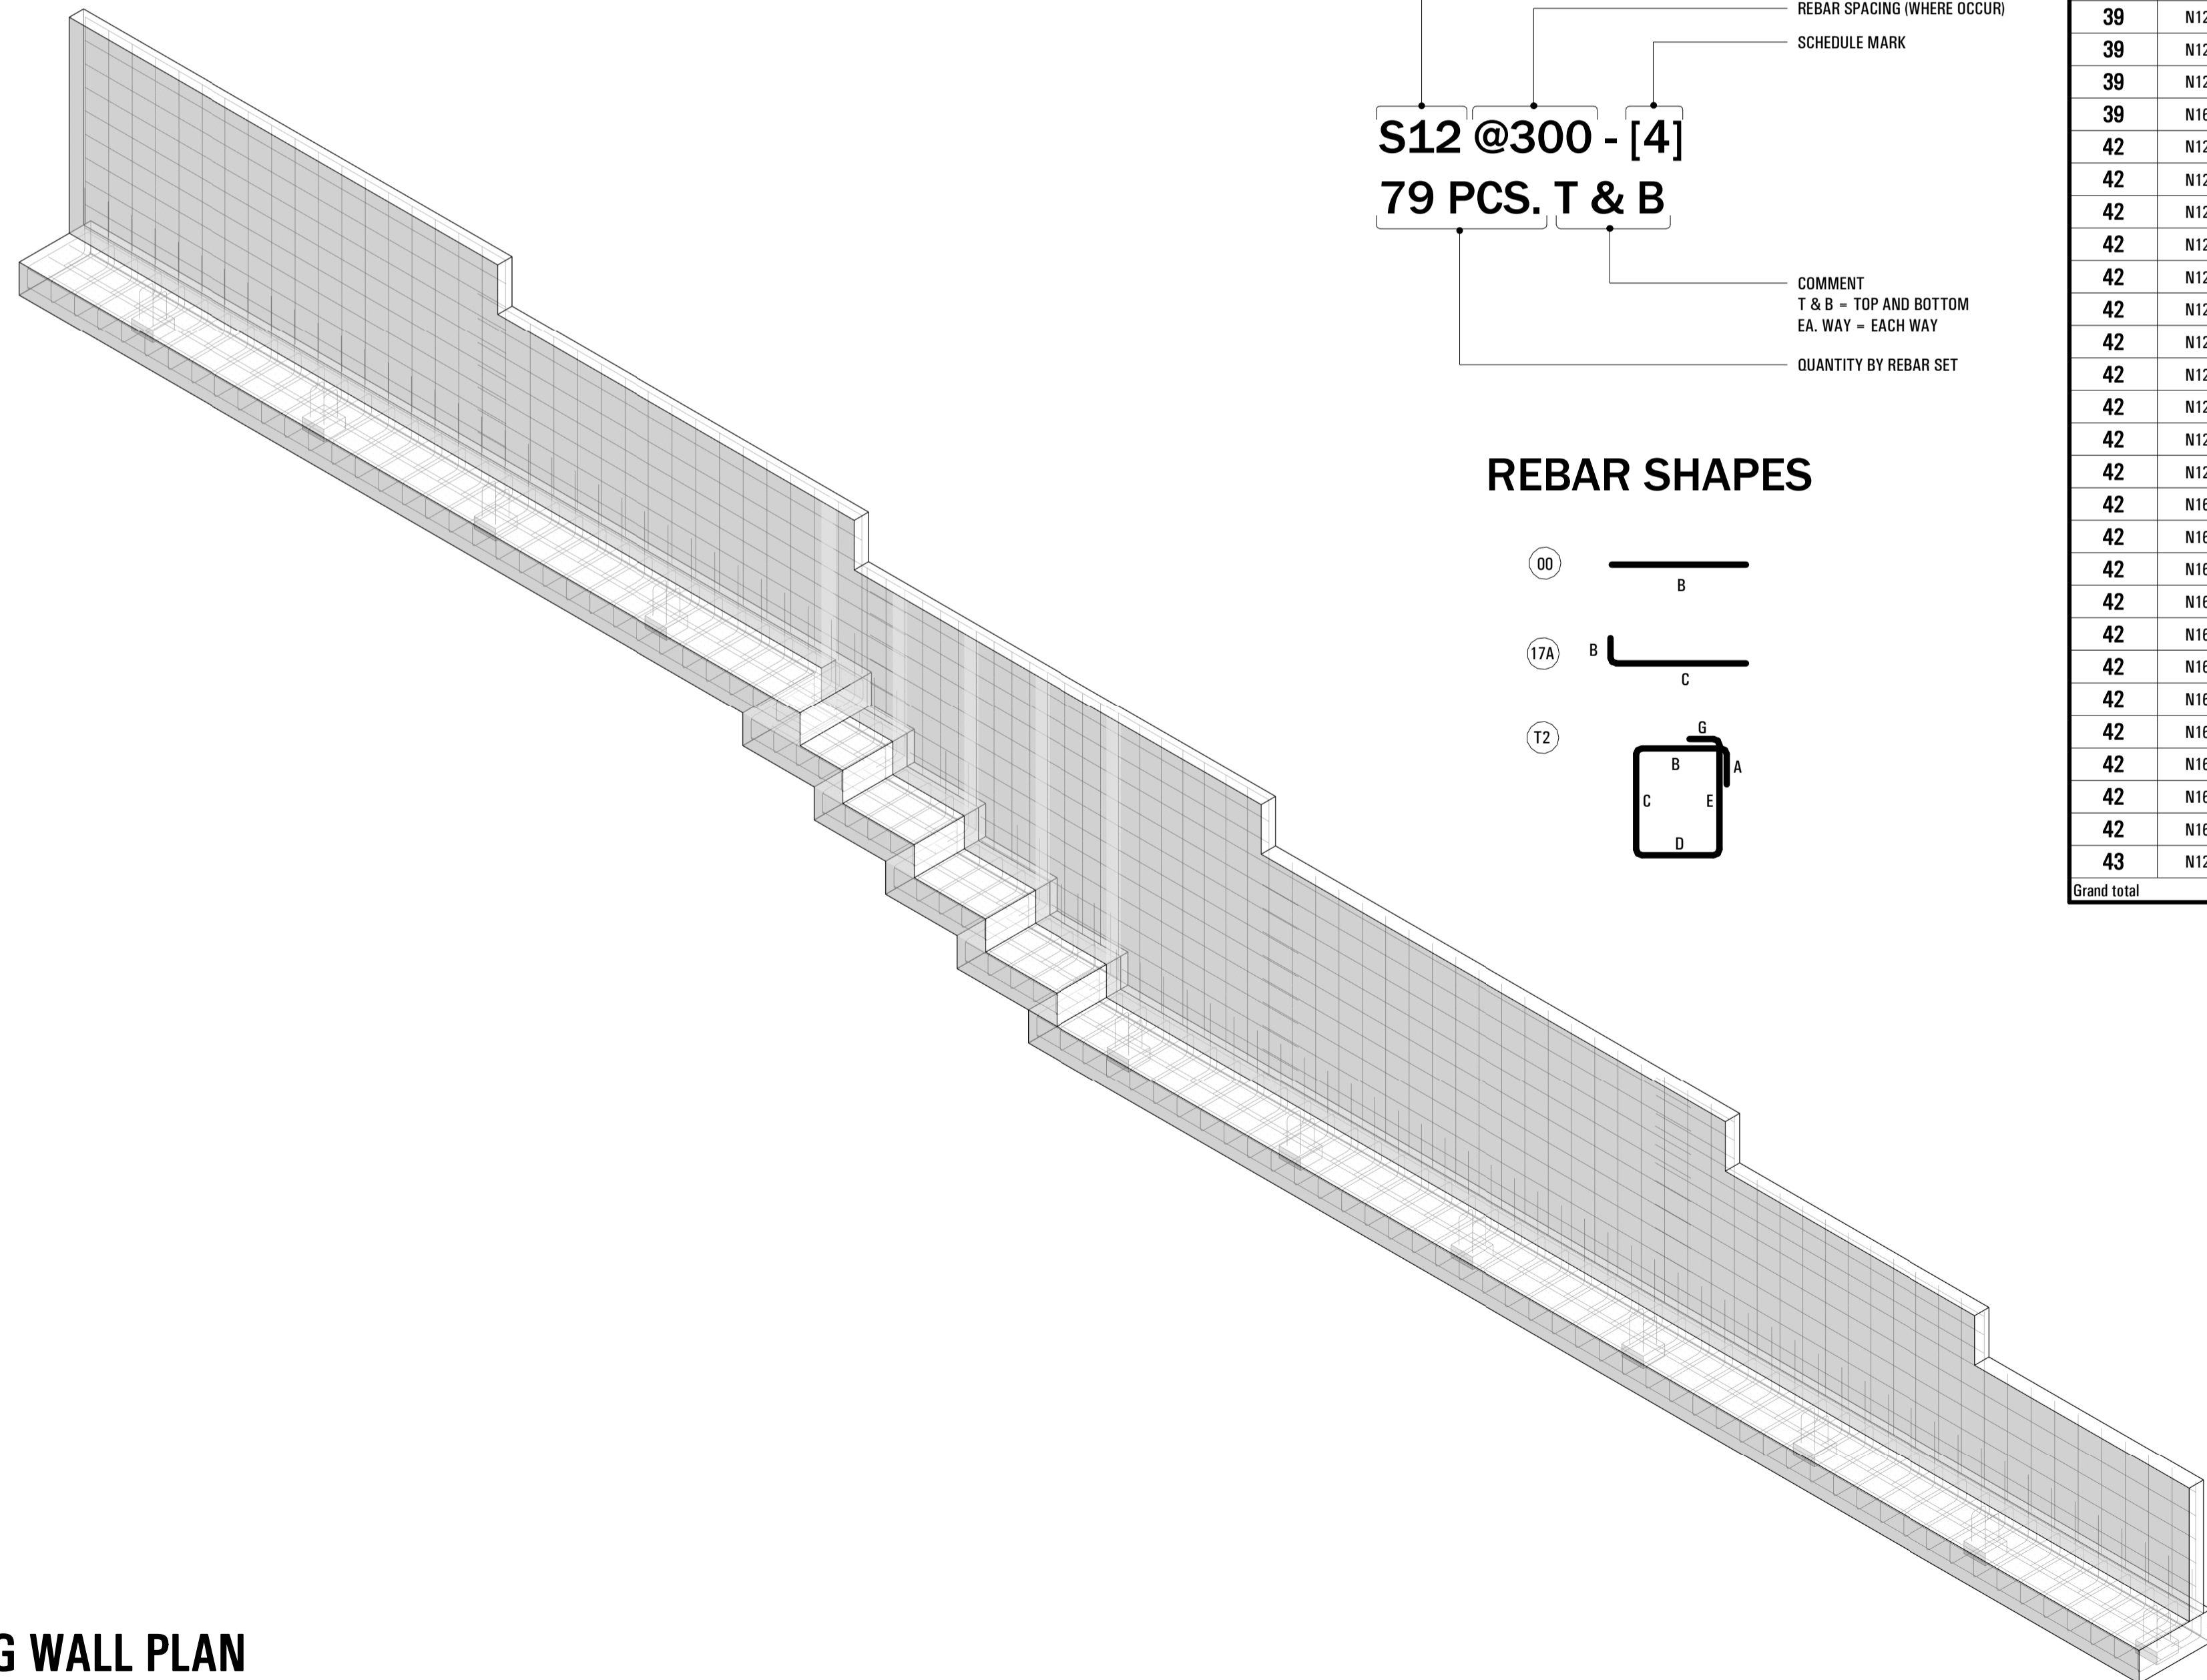

REBAR SHAPES

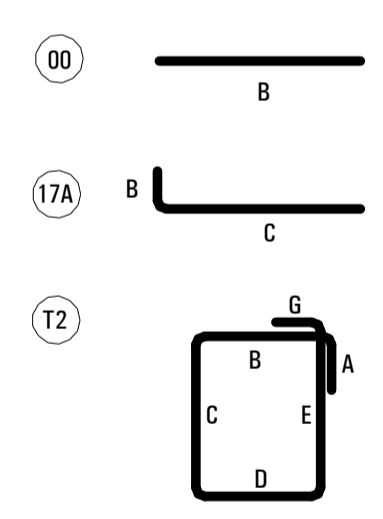

Rebar Schedule (S retaining wall)											
Schedule Mark	Bar Type	Shape	SIZE, (mm)						Total Bar Length, (mm)	Quantity	WEIGHT, (kg)
			A	B	C	D	E	G			
39	N12	00	0	1300	0	0	0	1300	32	38.27	
39	N12	00	0	4457	0	0	0	4457	8	32.80	
39	N12	00	0	5340	0	0	0	5340	8	39.30	
39	N12	00	0	6000	0	0	0	6000	24	132.48	
39	N16	T2	152	900	300	900	300	2538	102	421.95	
42	N12	00	0	1100	0	0	0	1100	3	3.04	
42	N12	00	0	2100	0	0	0	2100	6	11.59	
42	N12	00	0	2480	0	0	0	2480	1	2.26	
42	N12	00	0	3480	0	0	0	3480	1	3.18	
42	N12	00	0	4450	0	0	0	4450	2	8.19	
42	N12	00	0	4612	0	0	0	4612	3	12.73	
42	N12	00	0	5393	0	0	0	5393	2	9.92	
42	N12	00	0	5439	0	0	0	5439	1	5.00	
42	N12	00	0	5592	0	0	0	5592	3	15.43	
42	N12	00	0	5900	0	0	0	5900	10	54.28	
42	N12	00	0	6000	0	0	0	6000	26	143.52	
42	N16	17A	0	802	302	0	0	1063	91	167.69	
42	N16	00	0	1551	0	0	0	1551	9	22.75	
42	N16	00	0	1699	0	0	0	1699	3	8.31	
42	N16	00	0	1922	0	0	0	1922	15	46.98	
42	N16	00	0	2132	0	0	0	2132	4	13.90	
42	N16	00	0	2141	0	0	0	2141	11	38.39	
42	N16	00	0	2509	0	0	0	2509	19	77.70	
42	N16	00	0	2548	0	0	0	2548	4	16.61	
42	N16	00	0	2741	0	0	0	2741	20	89.36	
42	N16	00	0	2947	0	0	0	2947	4	19.21	
42	N16	00	0	3341	0	0	0	3341	7	38.12	
43	N12	T2	114	200	450	200	450	1402	22	28.38	
Grand total									441	1491.38	

1 SOUTH RETAINING WALL PLAN
SCALE: 1:50

SEAL:

CONTACT:

PROJECT:


**REBAR SHOP DRAWINGS FOR
RESIDENCE AT
10 DUNCAN PLACE, NORTH ROCKS, NSW 2151**

REVISIONS		
MARK	DATE	DESCRIPTION


PROJECT NO:
SCALE: As indicated
DATE: 09/30/20
DRAWN BY:
CHECKED BY:

SHEET TITLE:
SOUTH RETAINING WALL


SHEET NO:
SD104

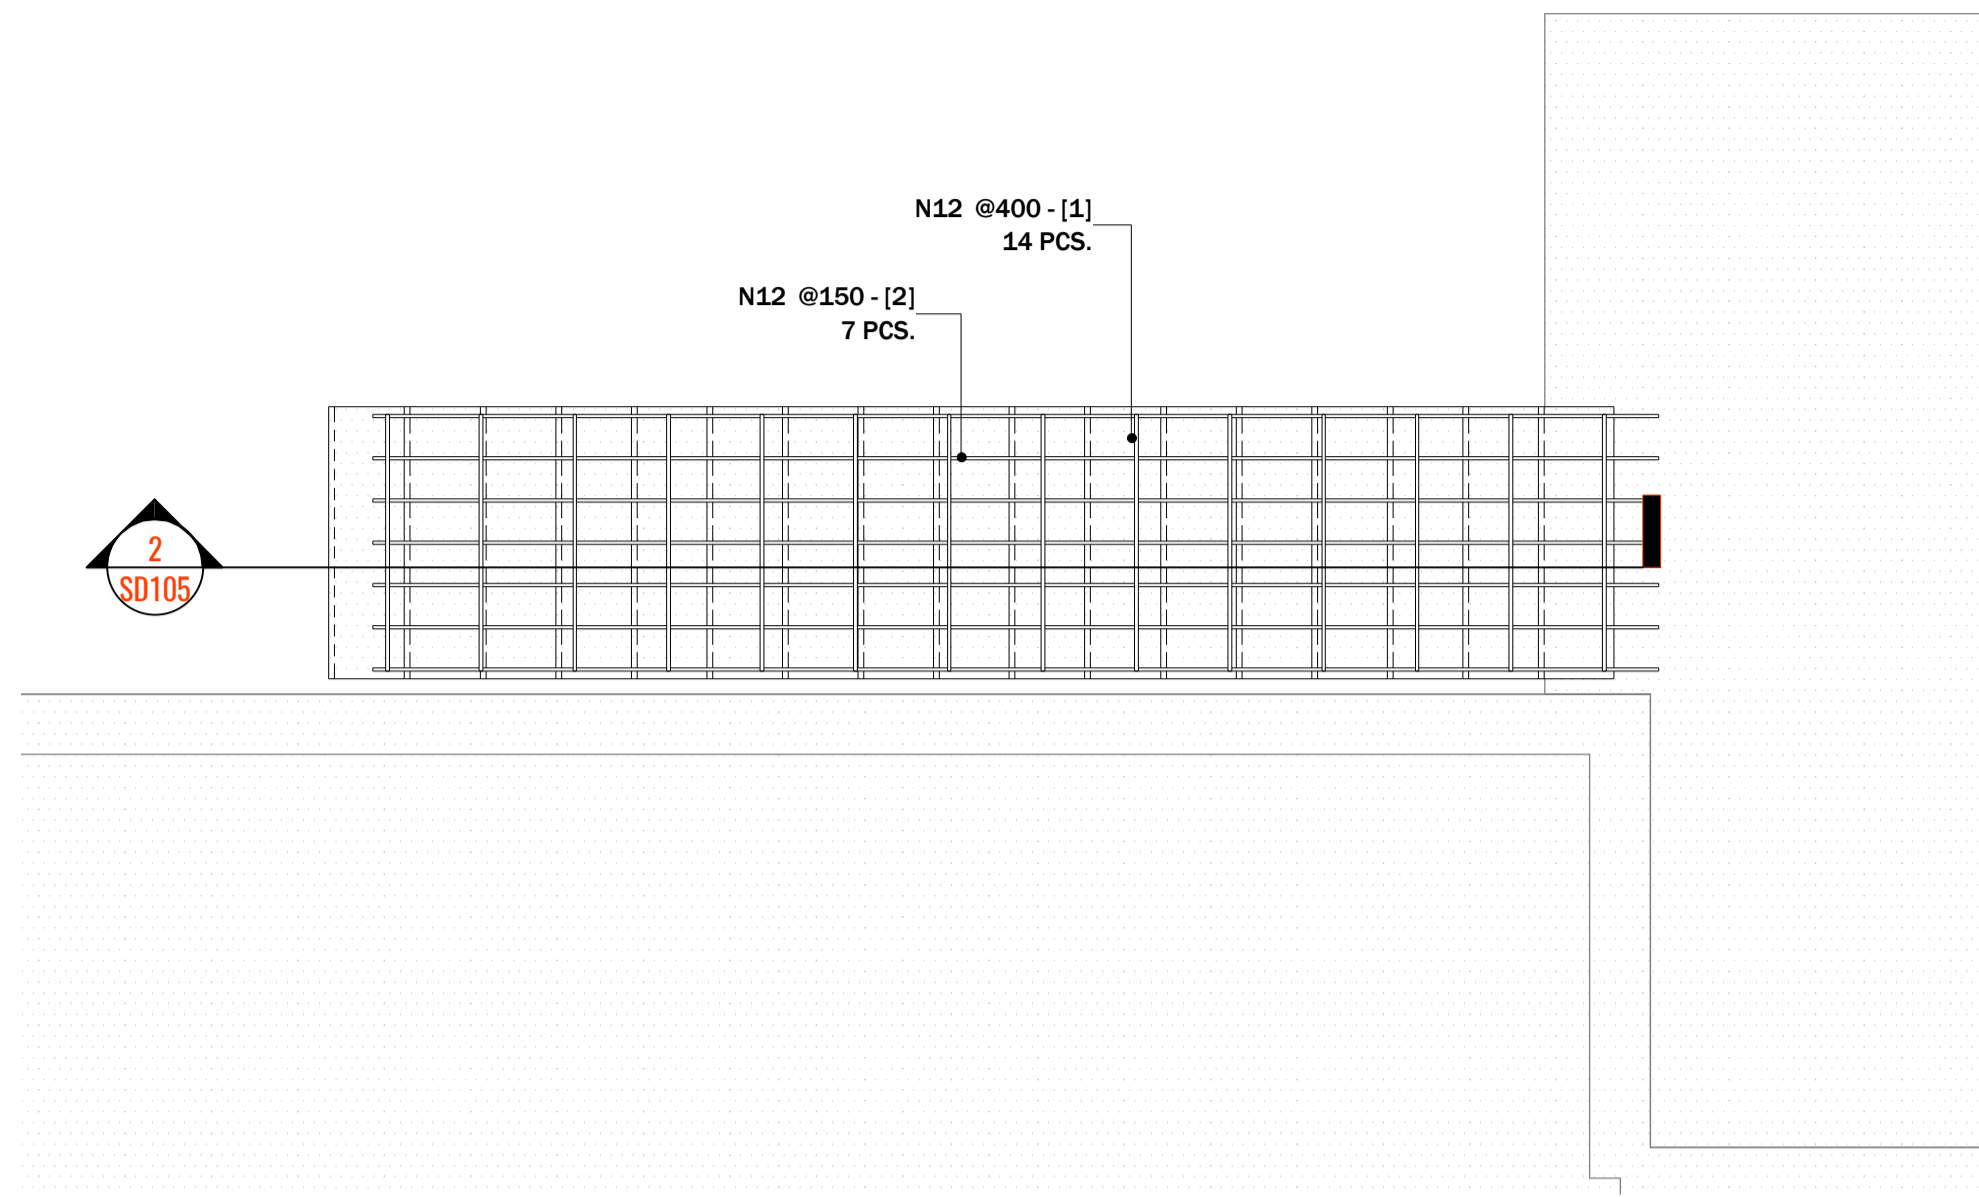

1 STAIRS PLAN
SCALE: 1:25

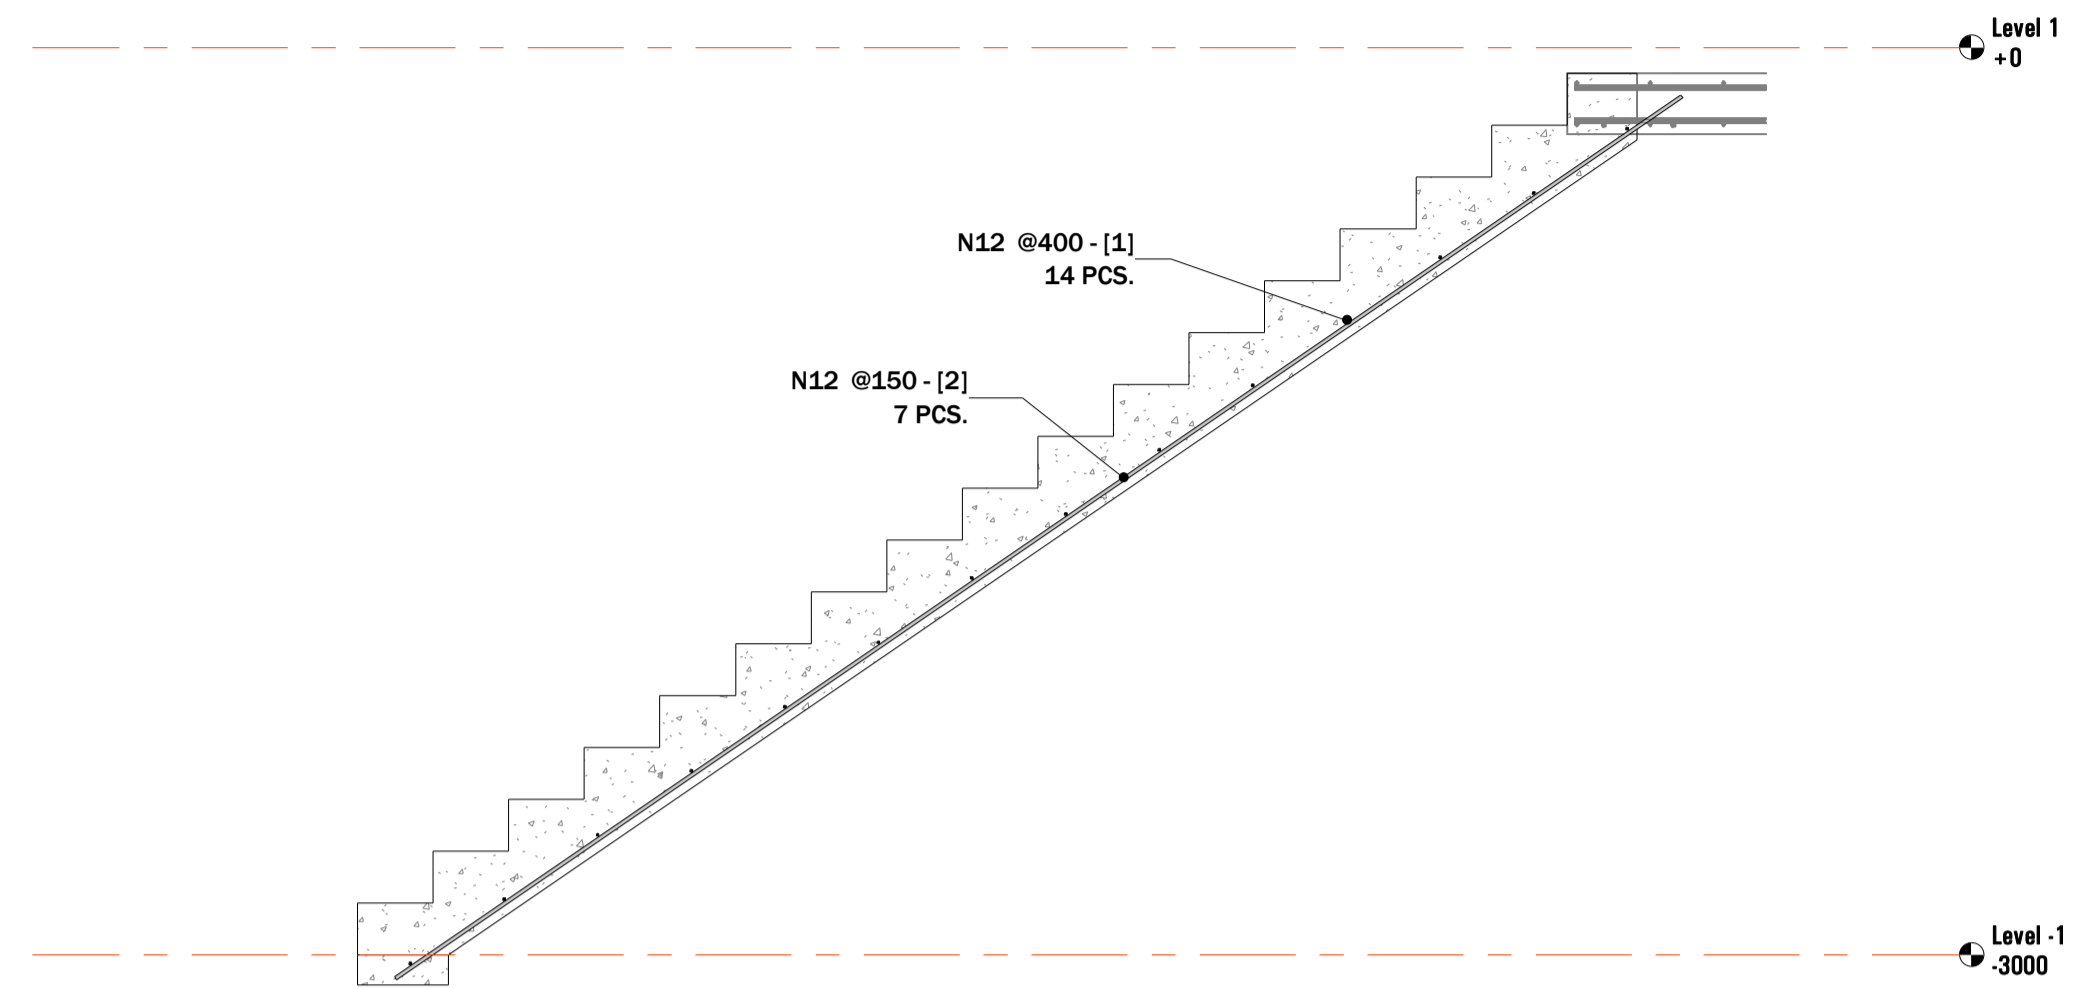


2 STAIRS SECTION
SCALE: 1:25

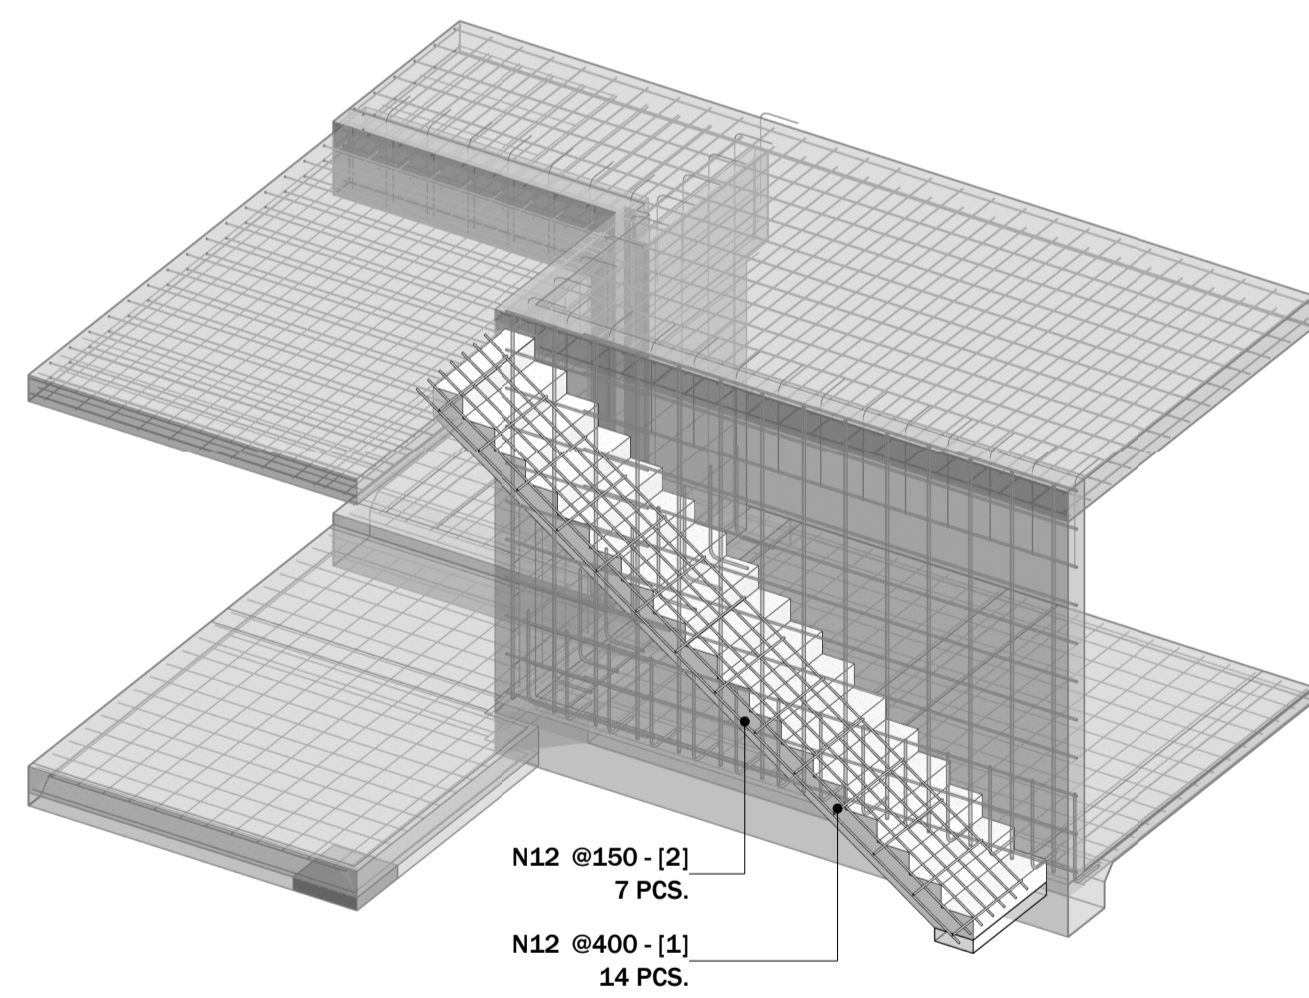

3 STAIRS 3D VIEW
SCALE:

Rebar Schedule (Stairs)											
Schedule Mark	Bar Type	Shape	SIZE, (mm)						Total Bar Length (mm)	Quantity	WEIGHT, (kg)
			A	B	C	D	E	G			
1	N12	00	0	850	0	0	0	0	850	14	10.95
2	N12	00	0	5156	0	0	0	0	5156	7	33.21
Grand total										21	44.16

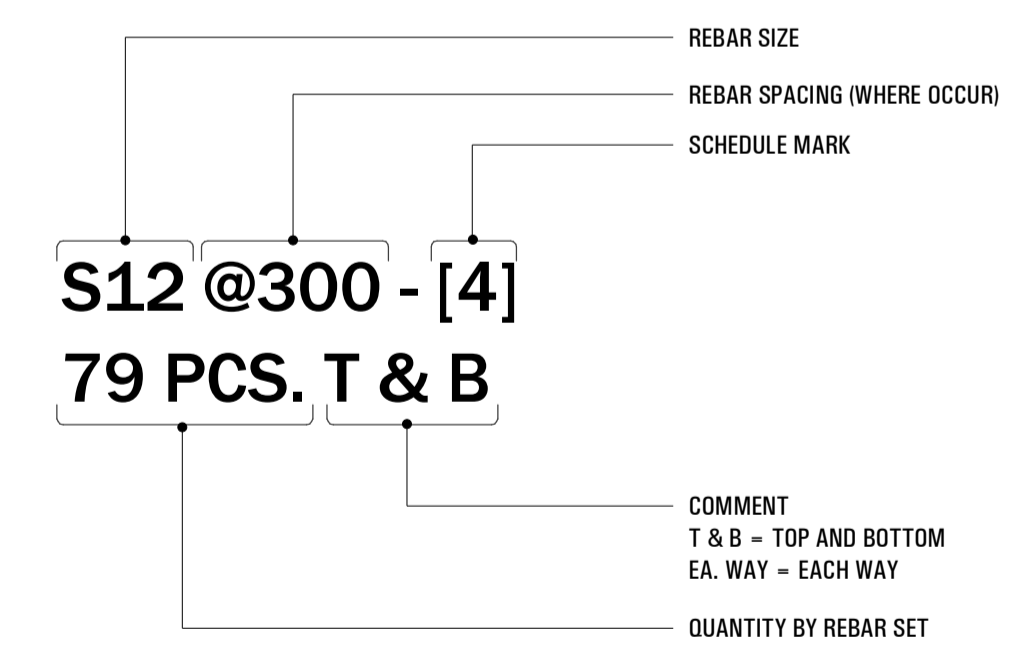

SEAL:

CONTACT:

PROJECT:

**REBAR SHOP DRAWINGS FOR
RESIDENCE AT
10 DUNCAN PLACE, NORTH ROCKS, NSW 2151**

REVISIONS

MARK	DATE	DESCRIPTION

PROJECT NO:

SCALE: As indicated

DATE: 10/01/20

DRAWN BY:


CHECKED BY:

SHEET TITLE:


STAIRS

SHEET NO:

SD105

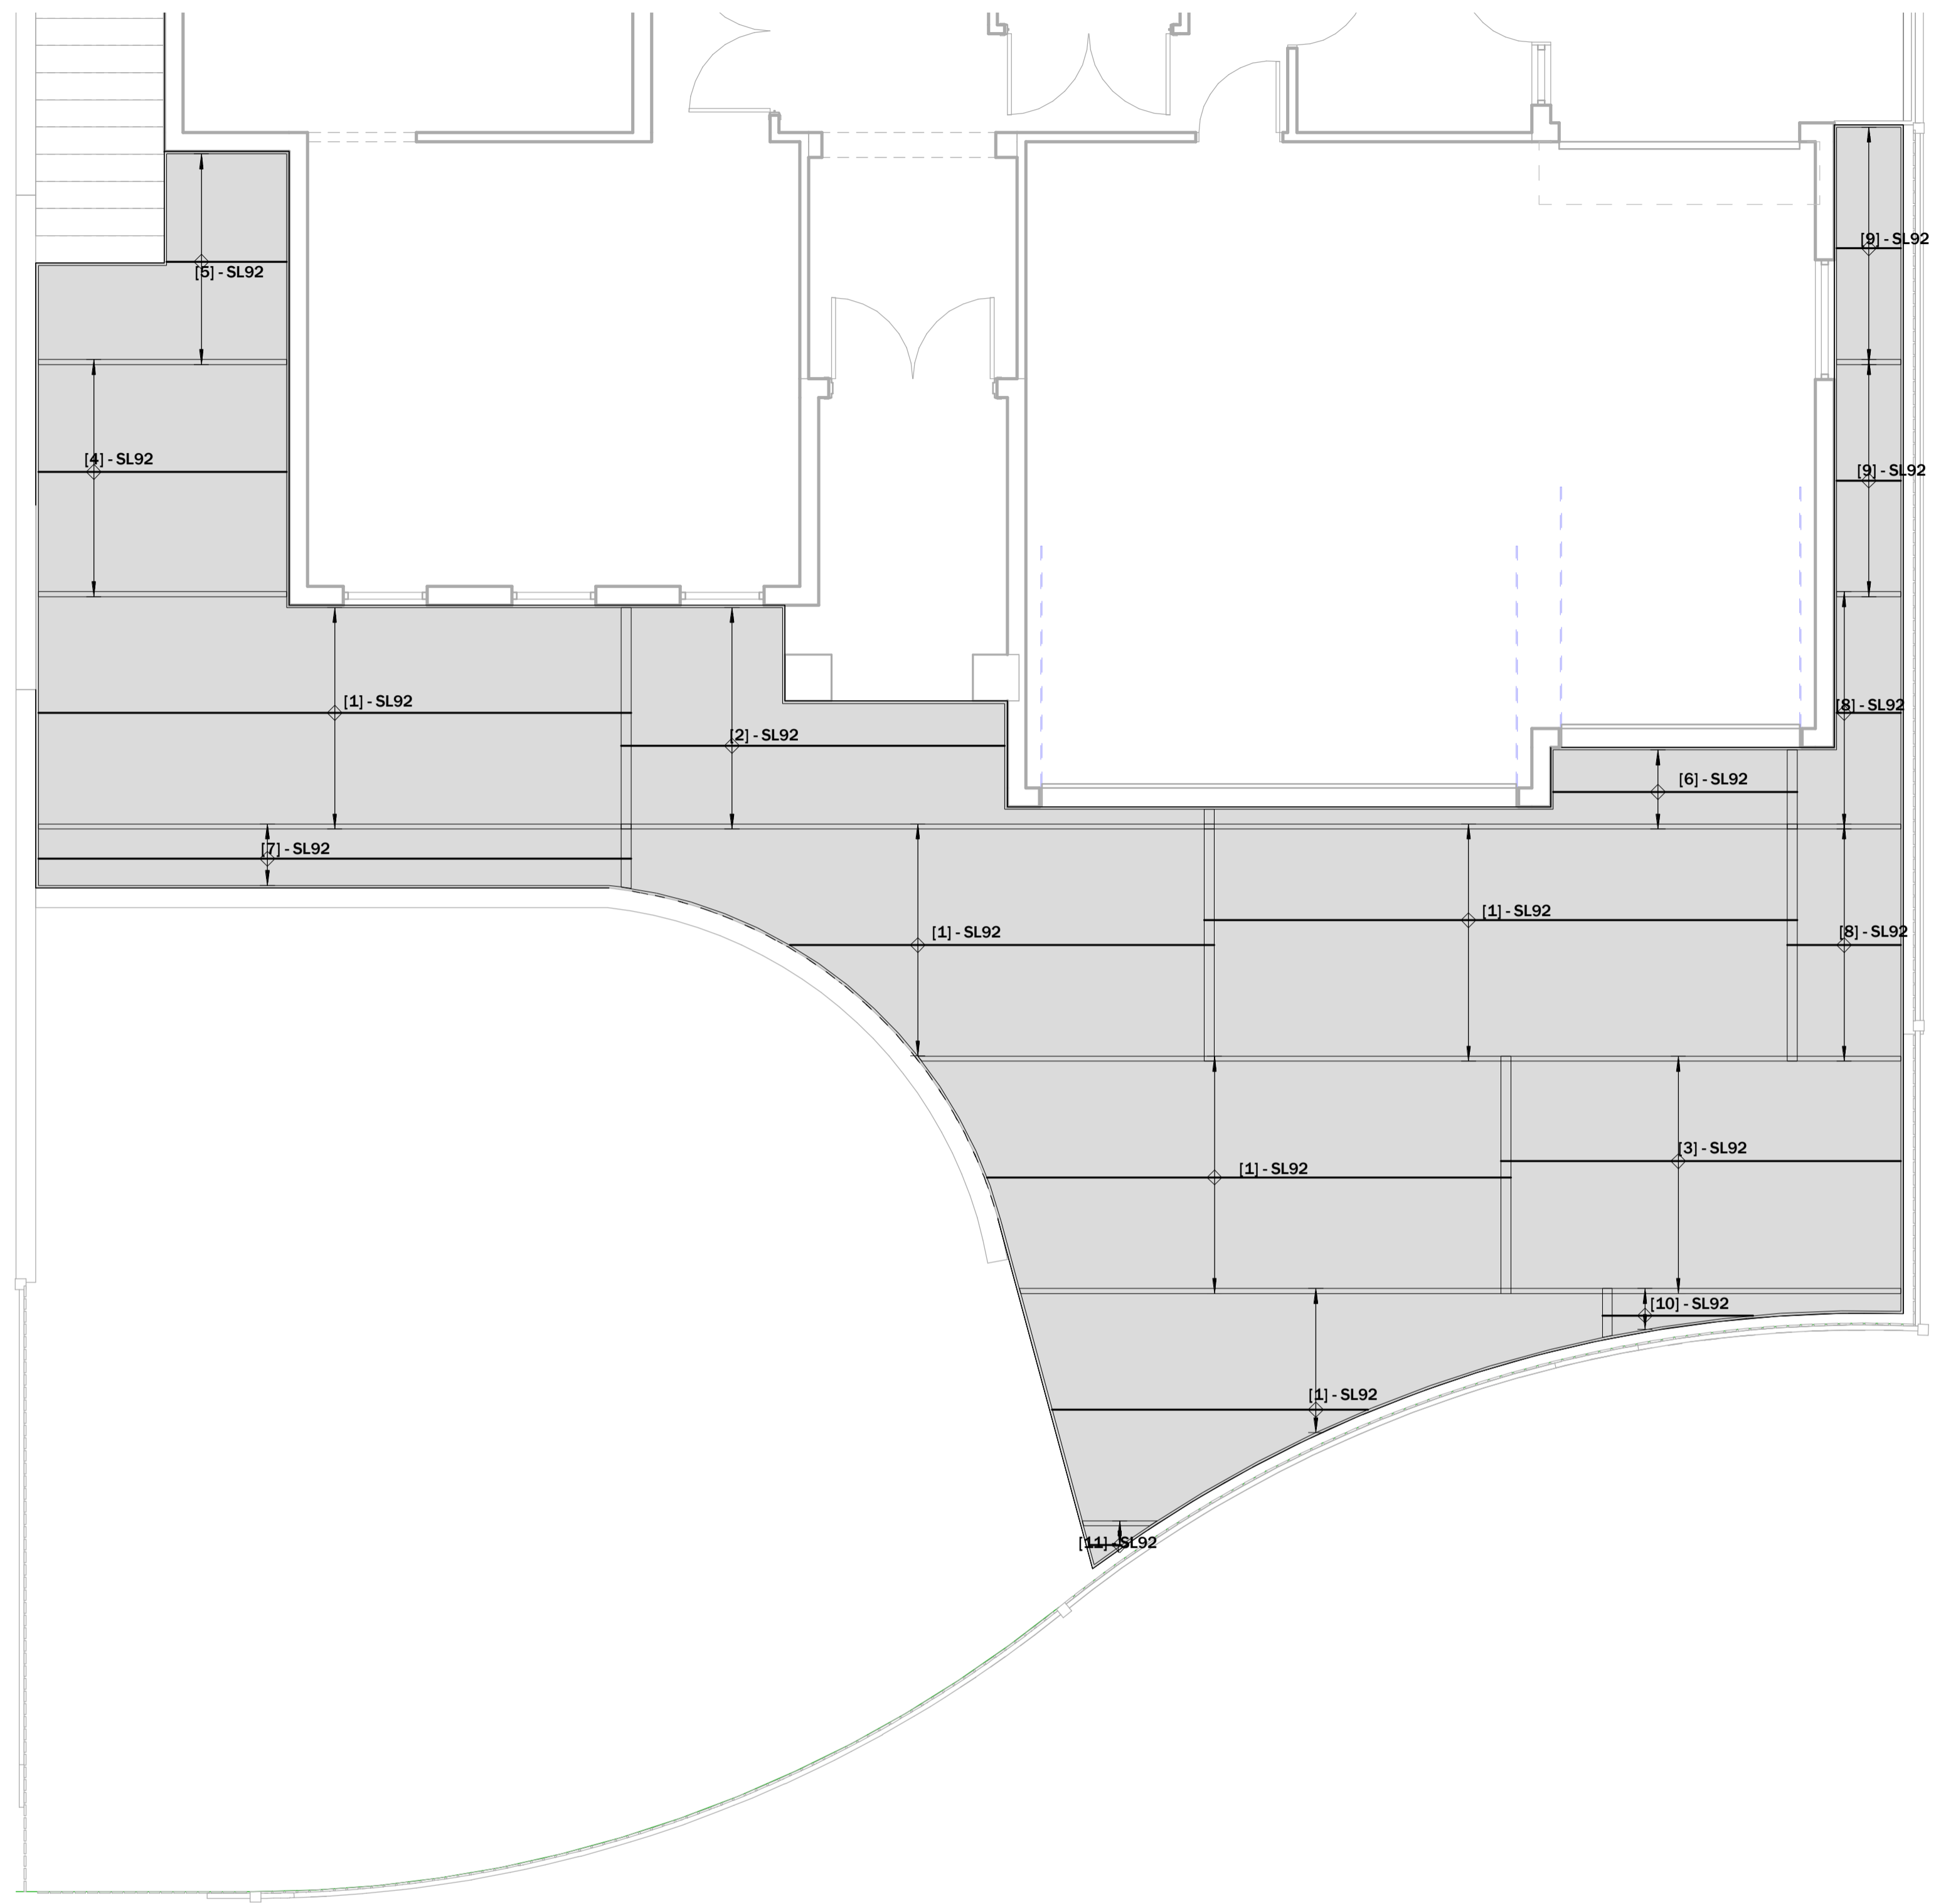

Fabric Reinforcement Schedule (Driveway)					
Mark	Type	Cut Overall Length	Cut Overall Width	Count	Total weight
1	SL92	6000	2400	5	325.00 kg
2	SL92	6000	2240	1	60.67 kg
3	SL92	4048	2400	1	43.86 kg
4	SL92	2512	2400	1	27.21 kg
5	SL92	2512	2130	1	24.15 kg
6	SL92	6000	800	1	21.67 kg
7	SL92	6000	653	1	17.68 kg
8	SL92	1152	2400	2	24.95 kg
9	SL92	650	2400	2	14.08 kg
10	SL92	3023	496	1	6.77 kg
11	SL92	759	443	1	1.52 kg
					567.55 kg

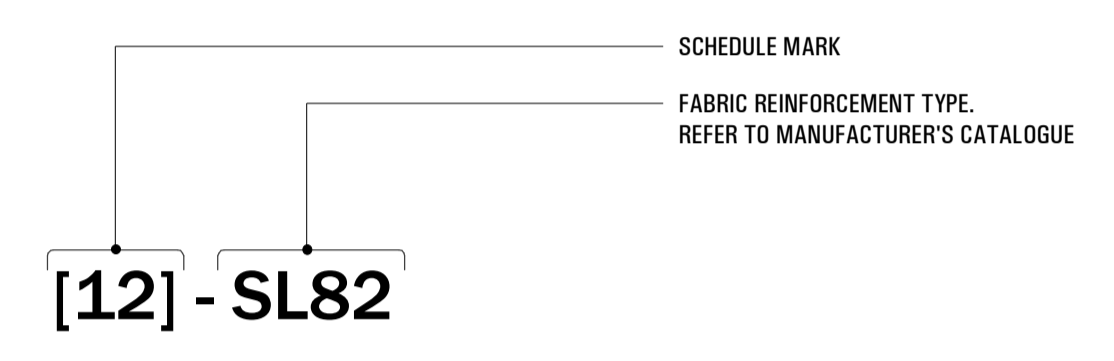

1

DRIVEWAY PLAN

SCALE: 1:48

SEAL:

CONTACT:

PROJECT:

**REBAR SHOP DRAWINGS FOR
RESIDENCE AT
10 DUNCAN PLACE, NORTH ROCKS, NSW 2151**

REVISIONS		
MARK	DATE	DESCRIPTION

PROJECT NO:

SCALE: As indicated

DATE: 10/02/20

DRAWN BY:


CHECKED BY:

SHEET TITLE:


DRIVEWAY

SHEET NO:

SD106

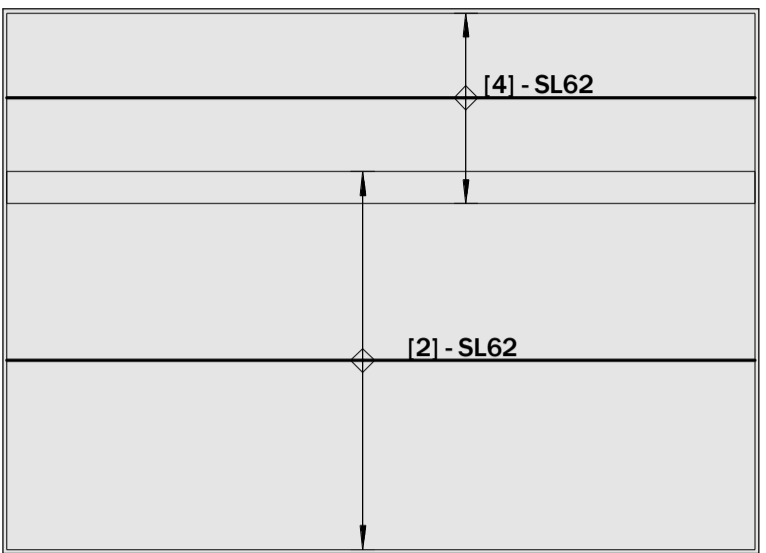

Fabric Reinforcement Schedule (Walkway)					
Mark	Type	Cut Overall Length	Cut Overall Width	Count	Total weight
1	SL62	6000	2150	1	29.56 kg
2	SL62	4750	2400	1	26.13 kg
3	SL62	8000	1202	3	49.56 kg
4	SL62	4750	1209	1	13.16 kg
5	SL62	433	2150	1	2.13 kg
					120.55 kg

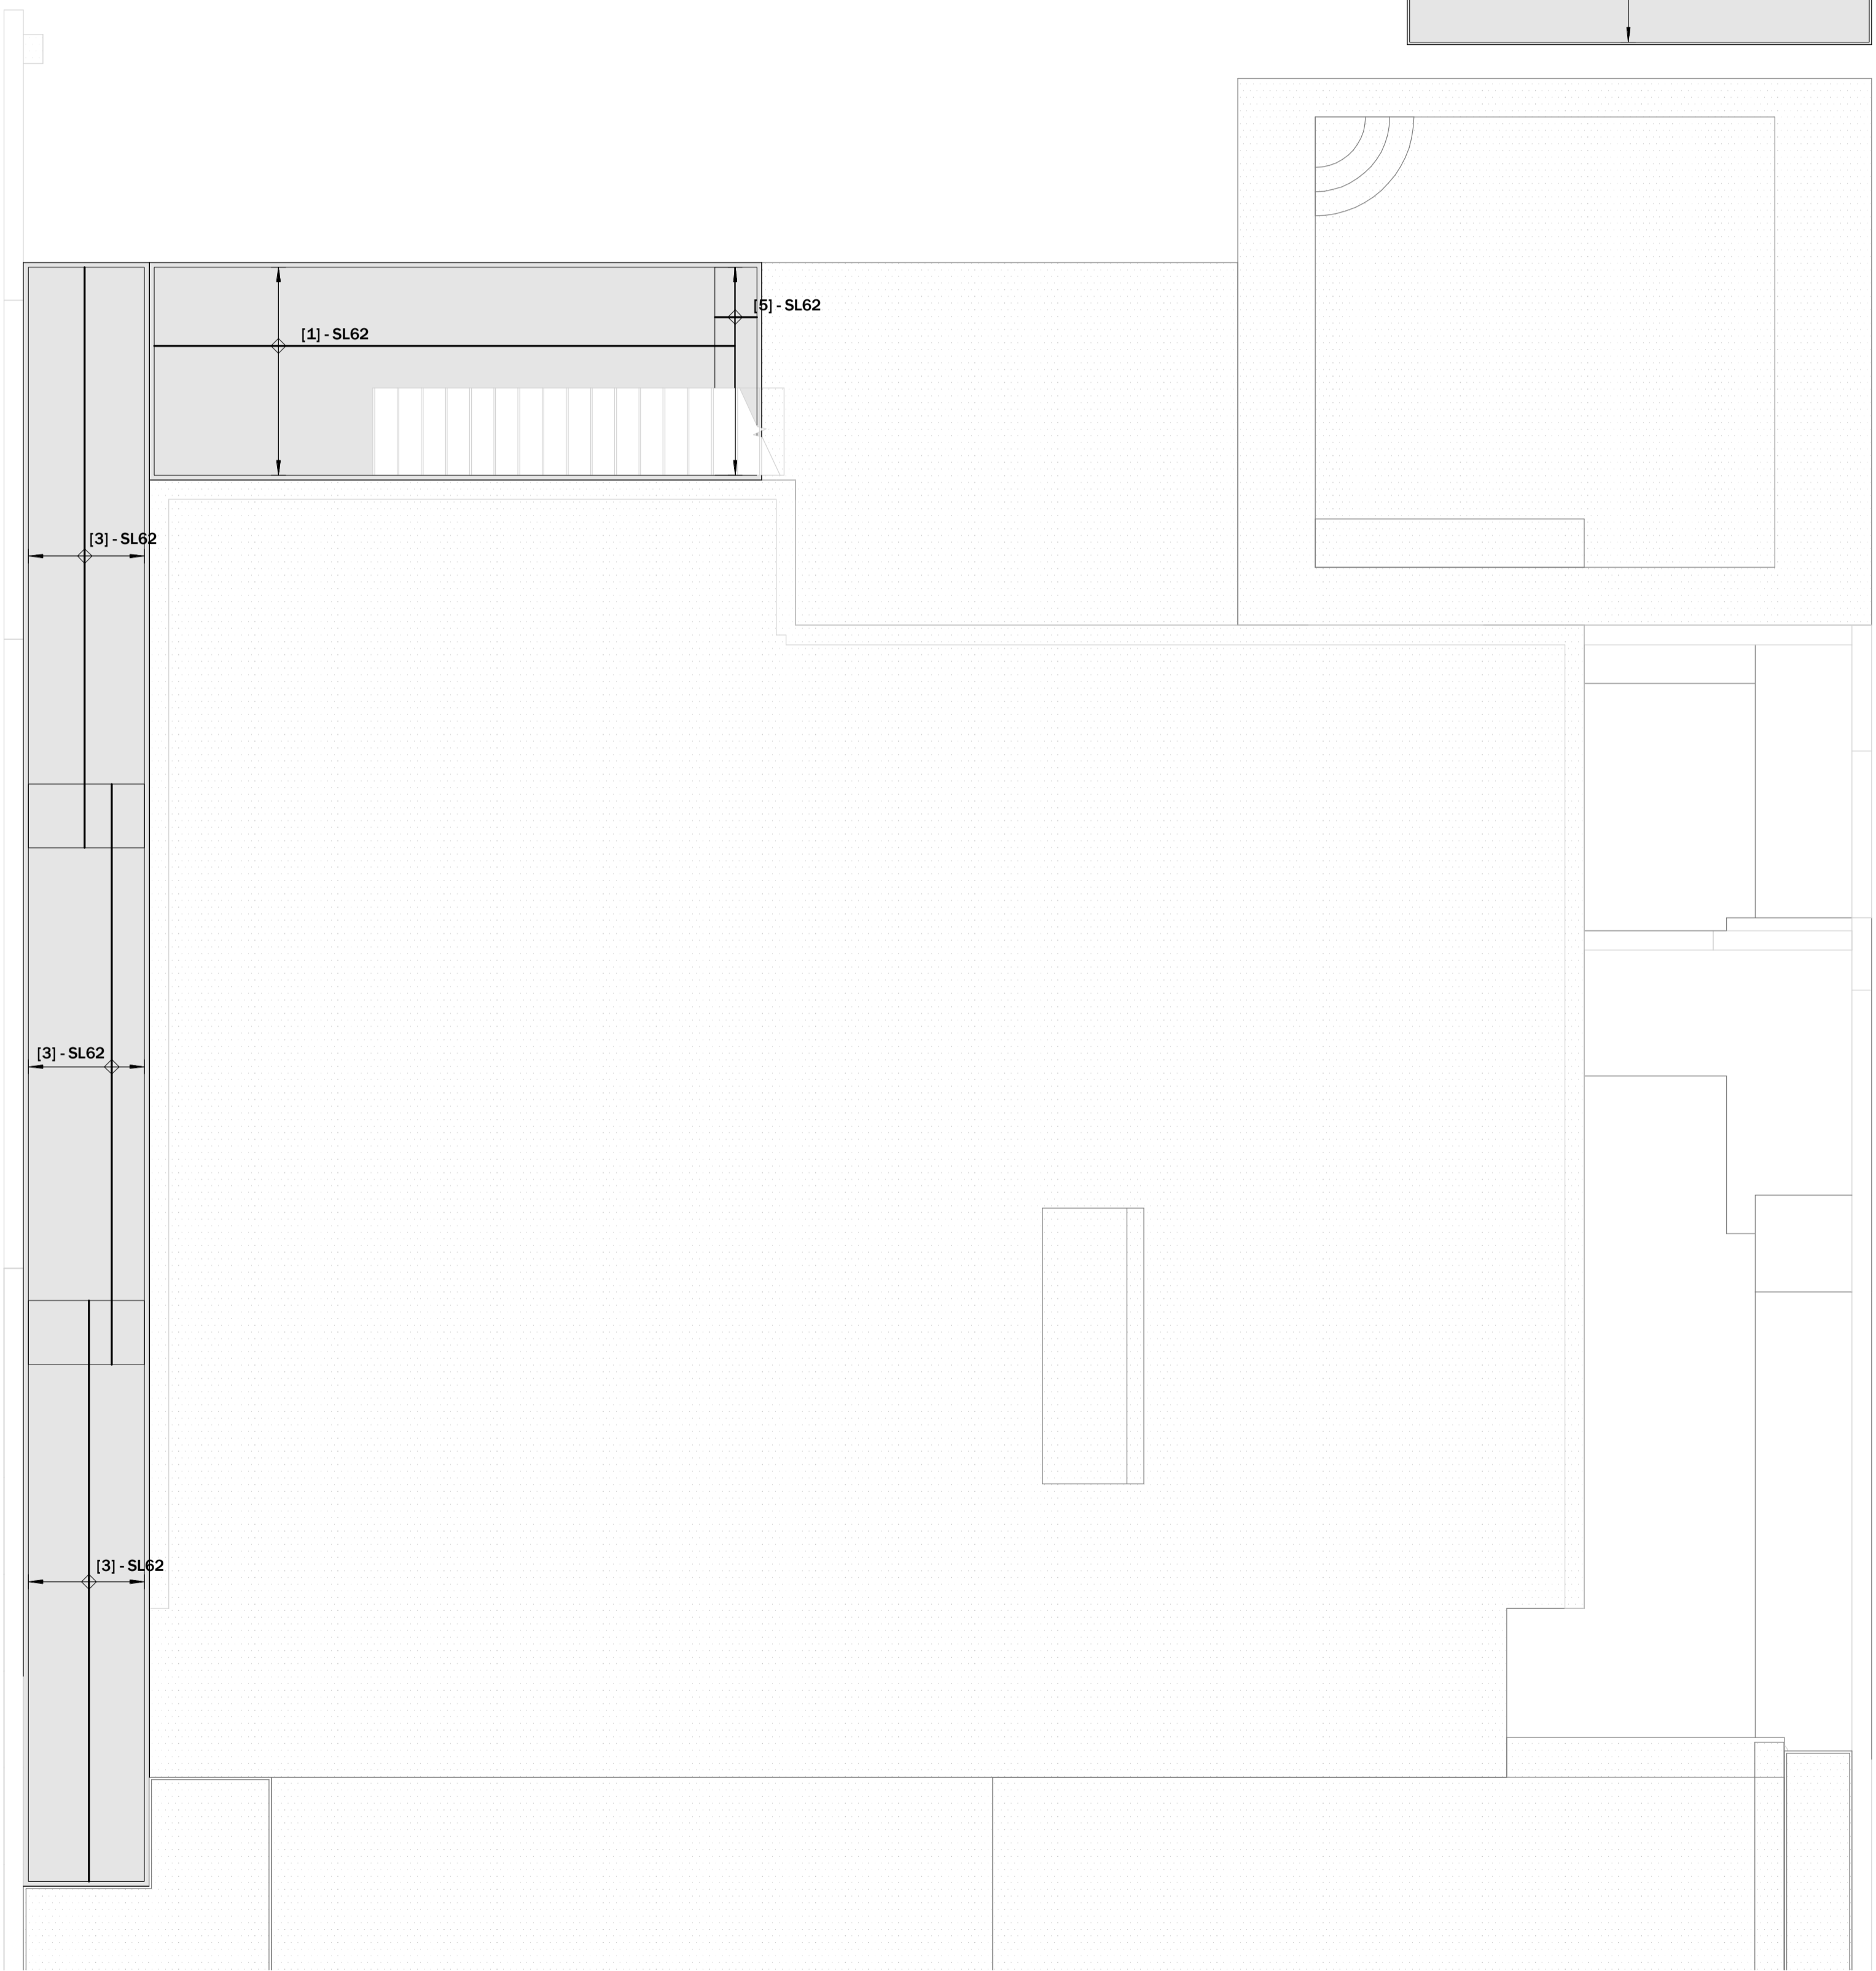

1

WALKWAY PLAN

SCALE: 1 : 48

SEAL:

CONTACT:

PROJECT:


**REBAR SHOP DRAWINGS FOR
RESIDENCE AT
10 DUNCAN PLACE, NORTH ROCKS, NSW 2151**

REVISIONS		
MARK	DATE	DESCRIPTION


PROJECT NO:
SCALE: As indicated
DATE: 10/02/20
DRAWN BY:
CHECKED BY:

SHEET TITLE:
WALKWAY

SHEET NO:
SD107

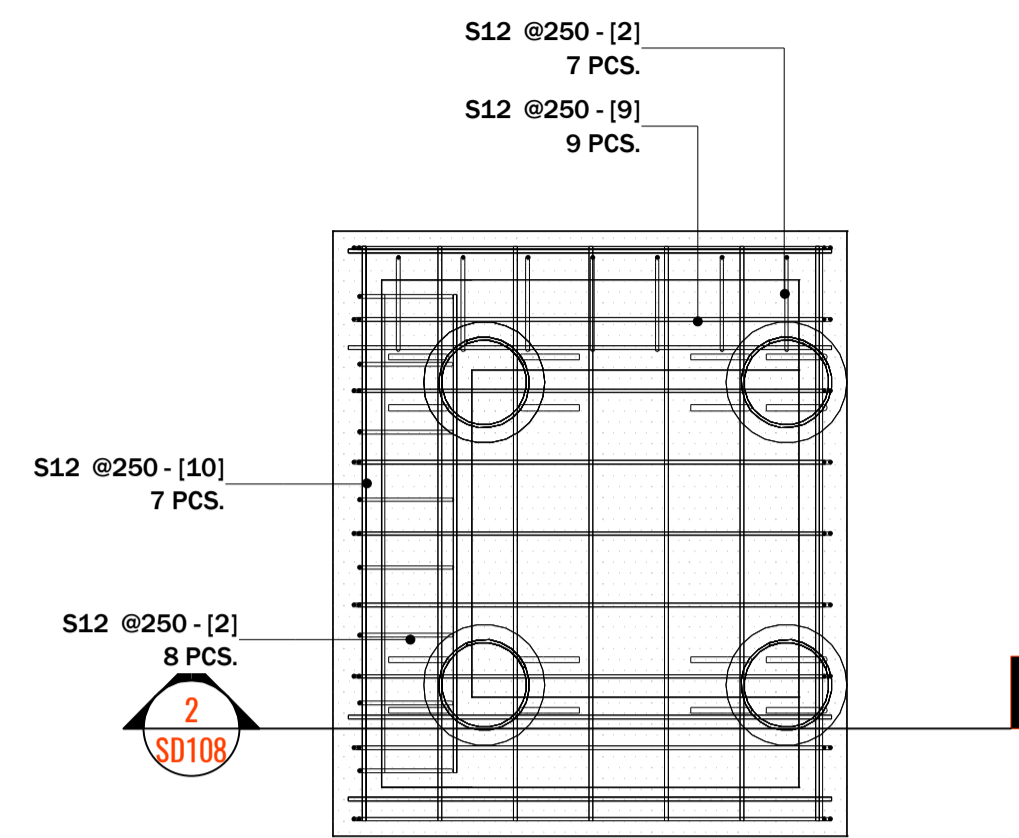

1 SPA PLAN
SCALE: 1 : 25



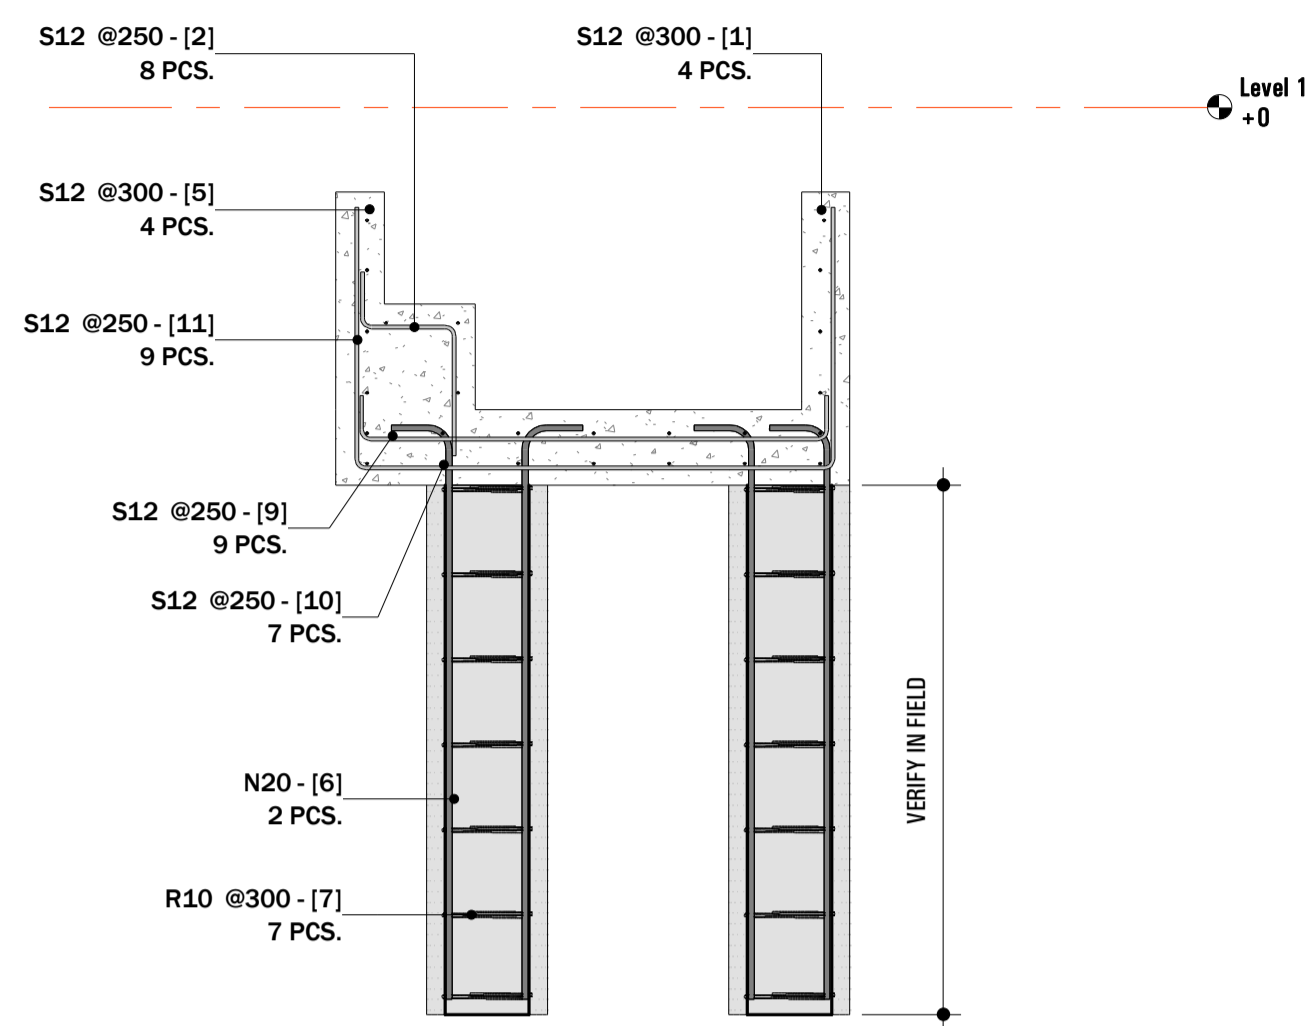


2 SPA SECTION
SCALE: 1 : 25

Schedule Mark	Bar Type	Shape	SIZE, [mm]							Total Bar Length, [mm]	Quantity	WEIGHT, [kg]	
			A	B	C	D	G	R	O				
1	S12	00	0	1900	0	0	0	0	0	0	1900	4	6.99
2	S12	20	0	432	316	188	0	0	0	0	885	15	12.21
3	S12	00	0	1580	0	0	0	0	0	0	1580	3	4.36
4	S12	00	0	1600	0	0	0	0	0	0	1600	4	5.89
5	S12	00	0	1900	0	0	0	0	0	0	1900	6	10.49
6	N20	17A	0	1900*	200	0	0	0	0	0	2050*	16	83.64
7	R10	T3	0	0	0	0	225	150	300	0	1136	28	19.72
8	S12	00	0	1600	0	0	0	0	0	0	1600	8	11.78
9	S12	17	0	150	1550	150	0	0	0	0	1799	9	14.90
10	S12	00	0	1900	0	0	0	0	0	0	1900	14 *	24.47
11	S12	17	0	869	1587	869	0	0	0	0	3274	9	27.10
Grand total											116	221.55	

* MEANS VERIFY IN FIELD

REBAR SHAPES

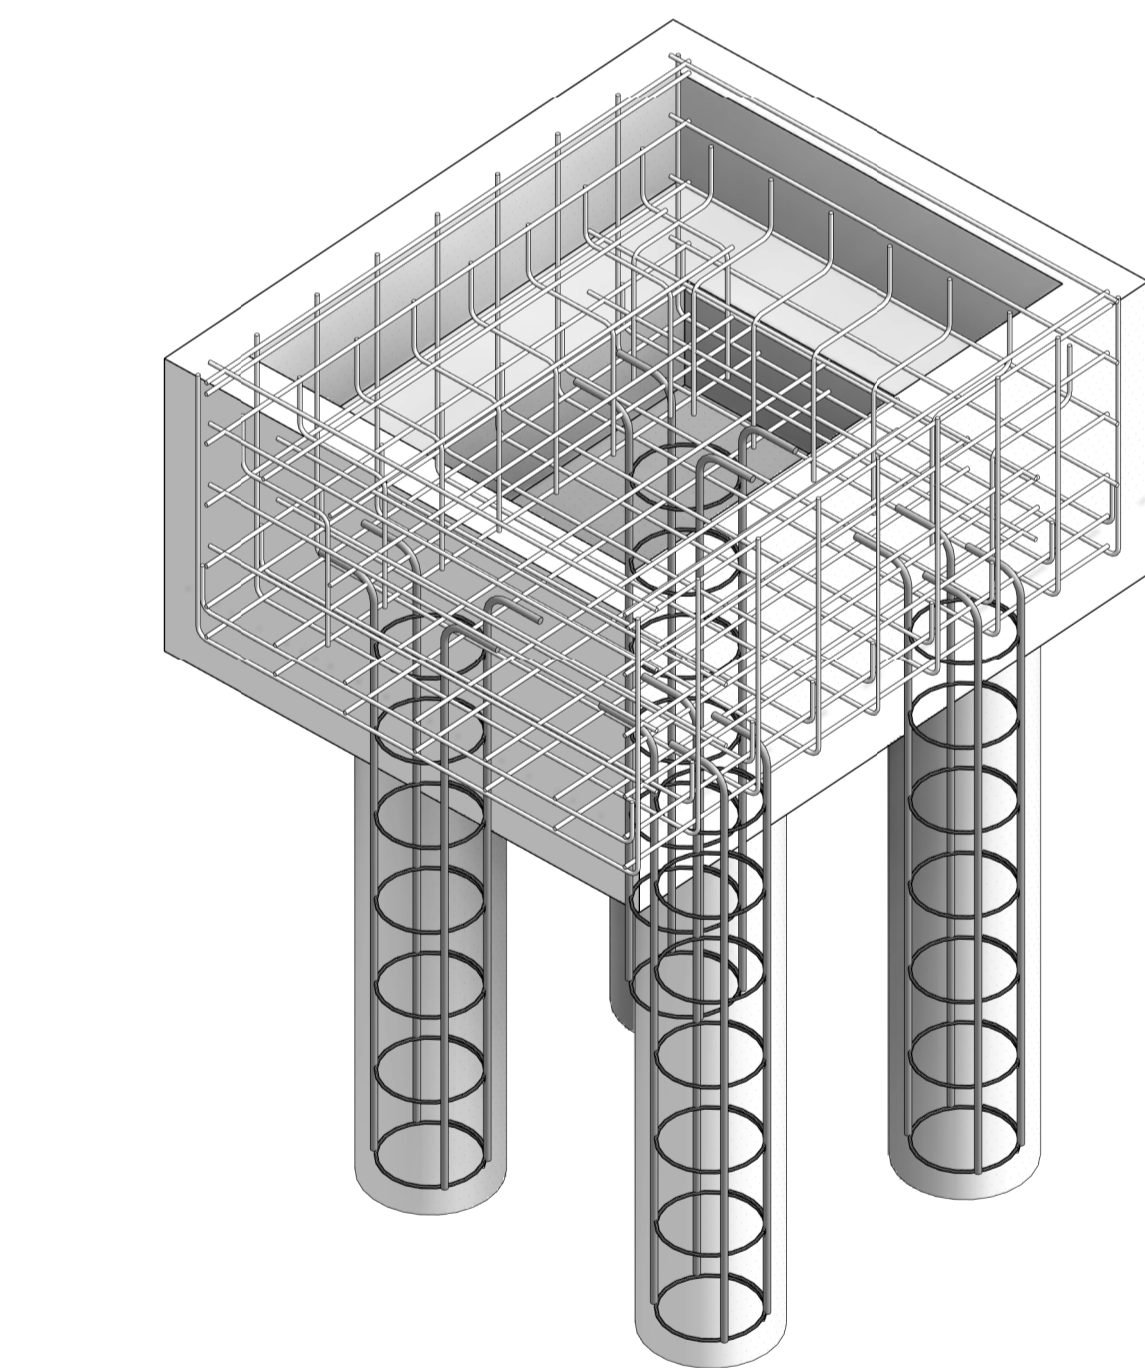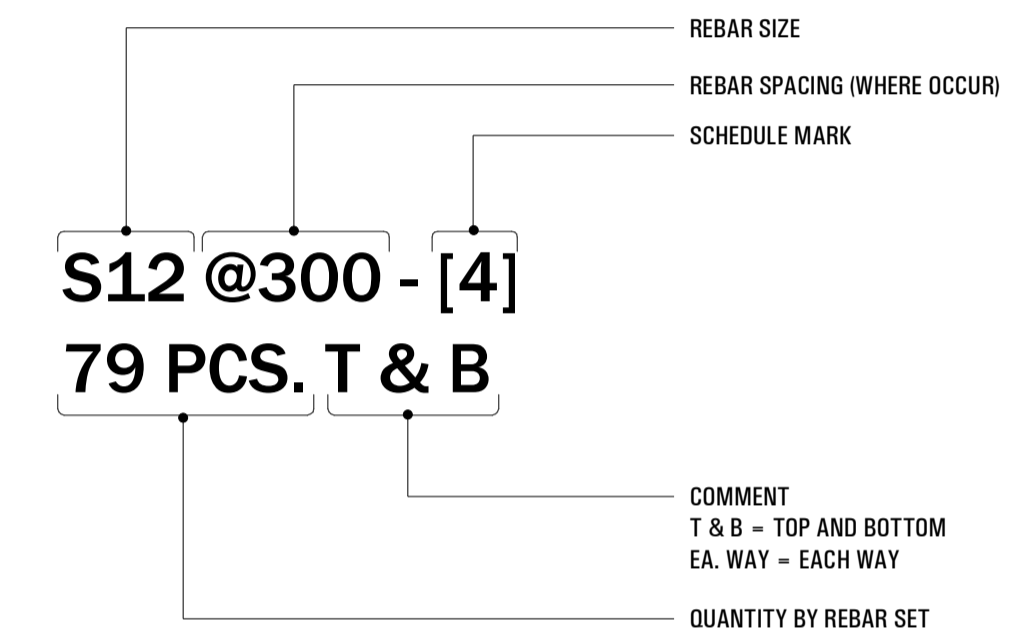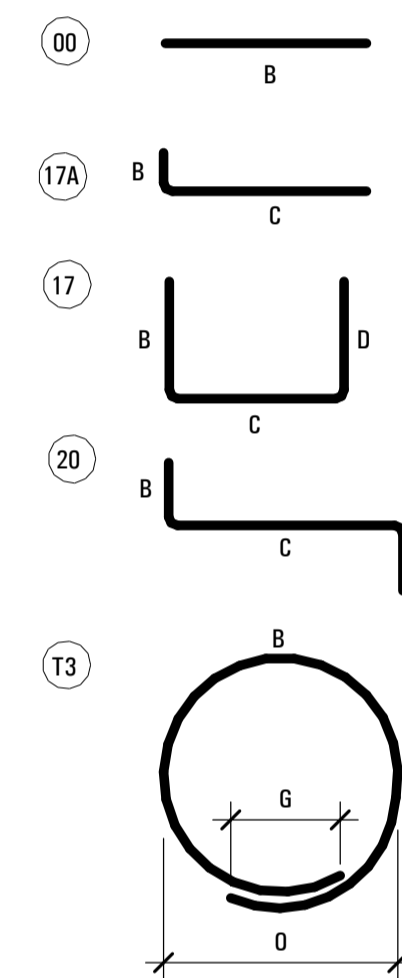

3 SPA 3D VIEW
SCALE:

SEAL:

CONTACT:

PROJECT:

**REBAR SHOP DRAWINGS FOR
RESIDENCE AT
10 DUNCAN PLACE, NORTH ROCKS, NSW 2151**

REVISIONS

MARK	DATE	DESCRIPTION

PROJECT NO:

SCALE: As indicated

DATE: 10/02/20

DRAWN BY:

CHECKED BY:

SHEET TITLE:

SPA

SHEET NO:

SD108